
1308401C - TAMWORTH MENTAL HEALTH UNIT DEAN STREET, TAMWORTH NSW CIVIL & STORMWATER


DRAWING No.	DESCRIPTION
13084-01-C101	EARLY WORKS COVER PAGE AND DRAWING REGISTER
13084-01-C102	EARLY WORKS CONSTRUCTION NOTES
13084-01-C104	EARLY WORKS SEDIMENT & EROSION CONTROL PLAN - ZONE 2 - CARPARK B (NW) - SHEET 1
13084-01-C105	EARLY WORKS SEDIMENT & EROSION CONTROL PLAN - ZONE 1 - CARPARK D (NE) - SHEET 2
13084-01-C106	EARLY WORKS SEDIMENT & EROSION CONTROL PLAN - ZONE 3 - CARPARK A ROAD (SOUTH) - SHEET :
13084-01-C107	EARLY WORKS SEDIMENT & EROSION CONTROL PLAN - ZONE 4 - CARPARK A (SOUTH) - SHEET 4
13084-01-C108	EARLY WORKS SEDIMENT & EROSION CONTROL DETAILS
13084-01-C111	EARLY WORKS BULK EARTHWORKS PLAN – ZONE 2 – CARPARK B (NW) – SHEET 1
13084-01-C112	EARLY WORKS BULK EARTHWORKS PLAN - ZONE 1 - CARPARK D (NE) - SHEET 2
13084-01-C113	EARLY WORKS BULK EARTHWORKS PLAN - ZONE 3 - CARPARK A ROAD (SOUTH) - SHEET 3
13084-01-C114	EARLY WORKS BULK EARTHWORKS PLAN - ZONE 4 - CARPARK A (SOUTH) - SHEET 4
13084-01-C115	EARLY WORKS BULK EARTHWORKS LONGITUDINAL SECTIONS
13084-01-C131	EARLY WORKS SITEWORKS PLAN - ZONE 2 - CARPARK B (NW) - SHEET 1
13084-01-C132	EARLY WORKS SITEWORKS PLAN - ZONE 1 - CARPARK D (NE) - SHEET 2
13084-01-C133	EARLY WORKS SITEWORKS PLAN - ZONE 3 - CARPARK A ROAD (SOUTH) - SHEET 3
13084-01-C134	EARLY WORKS SITEWORKS PLAN - ZONE 4 - CARPARK A (SOUTH) - SHEET 4
13084-01-C141	EARLY WORKS SITEWORKS DETAILS
13084-01-C151	EARLY WORKS ZONE 2 - CARPARK B (NW) - ON-SITE DETENTION TANK DETAILS - SHEET 1
13084-01-C152	EARLY WORKS ZONE 1 - CARPARK D (NE) - ON-SITE DETENTION TANK DETAILS
13084-01-C153	EARLY WORKS ZONE 4 - CARPARK A (SOUTH) - ON-SITE DETENTION TANK DETAILS
13084-01-C154	EARLY WORKS ZONE 2 – CARPARK B (NW) – ON-SITE DETENTION TANK DETAILS – SHEET 2
13084-01-C155	EARLY WORKS - ON-SITE DETENTION TANK DETAILS
13084-01-0170	EARLY WORKS PAVEMENT DETAILS

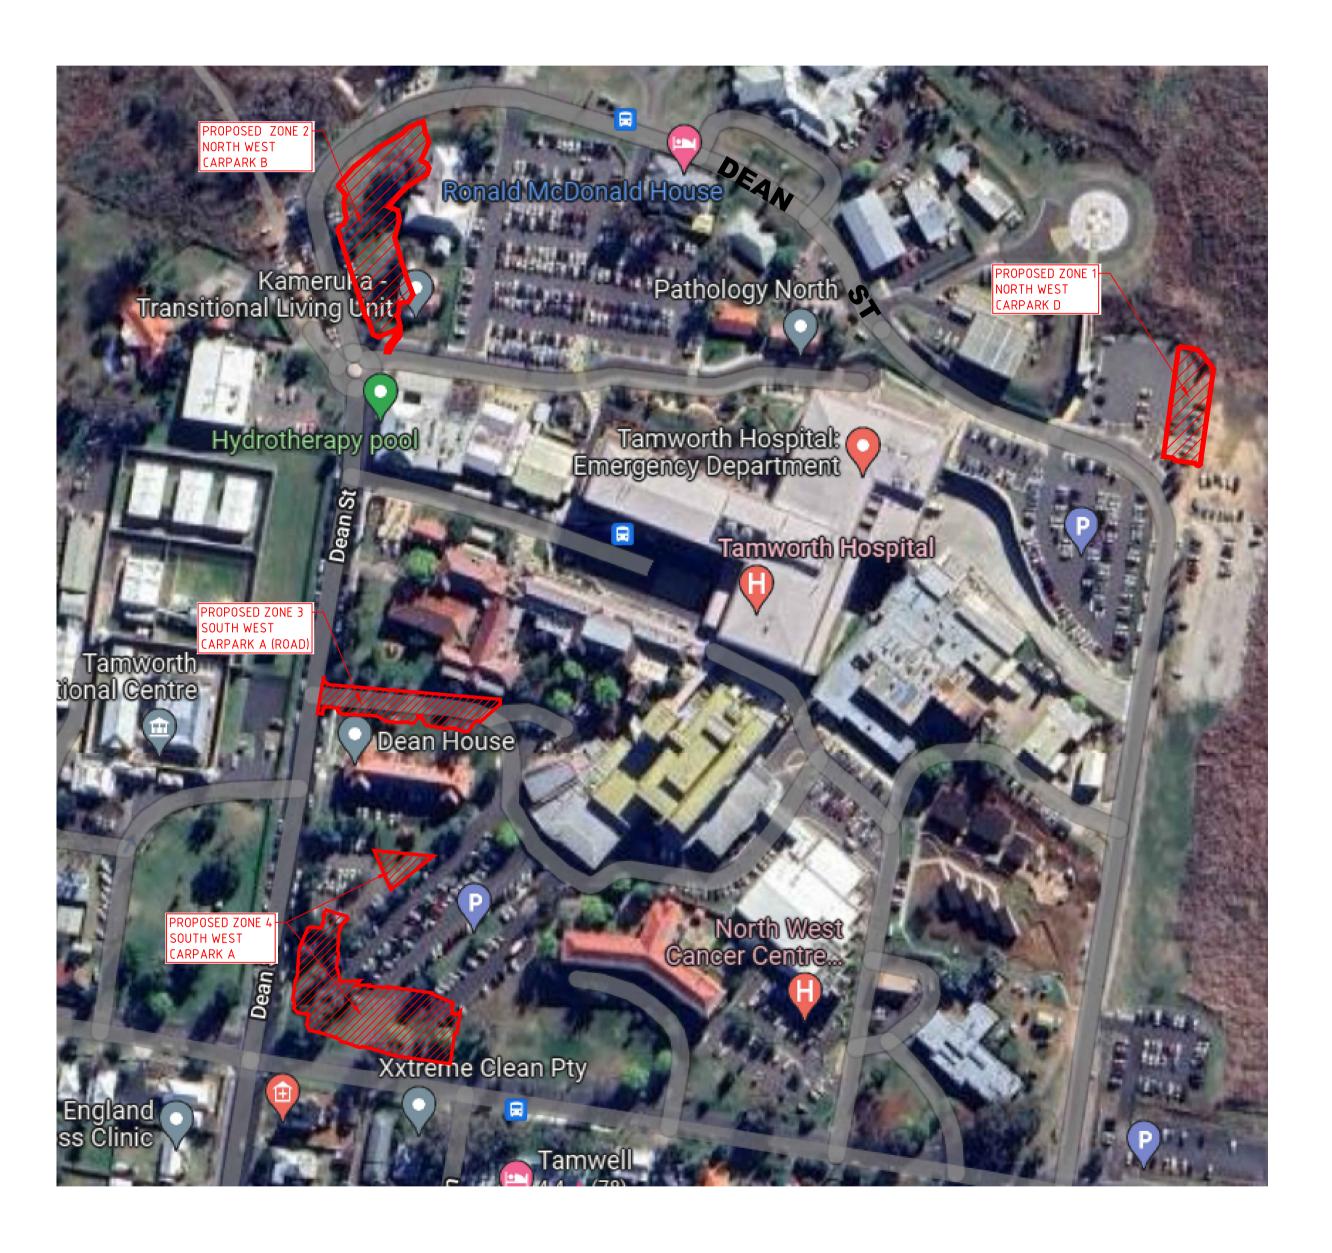





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28.10.22 DH Y

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SOIL AND WATER MANAGEMENT NOTES

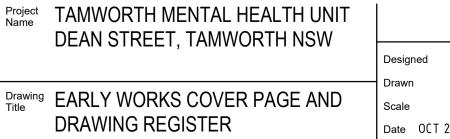- 1. IT HAS BEEN ASSUMED THAT HOARDINGS/SILT FENCING WILL BE PROVIDED TO THE SITE BOUNDARY SUFFICIENT TO PREVENT SEDIMENT RUNOFF FROM LEAVING SITE (EXCEPT IN THE CASE OF ENTRY/EXIT LOCATIONS WHERE TEMPORARY CONSTRUCTION ENTRY/EXIT SEDIMENT TRAP ARE PROVIDED). IF THIS IS NOT THE CASE, PROVIDE SEDIMENT FENCE TO STANDARD DETAIL AS REQUIRED TO PREVENT SEDIMENT FROM LEAVING SITE, DIRECT RUNOFF TO SEDIMENT
- ALL SEDIMENT CONTROL MEASURES TO BE INSTALLED IN ACCORDANCE WITH LANDCOM MANAGING URBAN STORMWATER "BLUE BOOK".

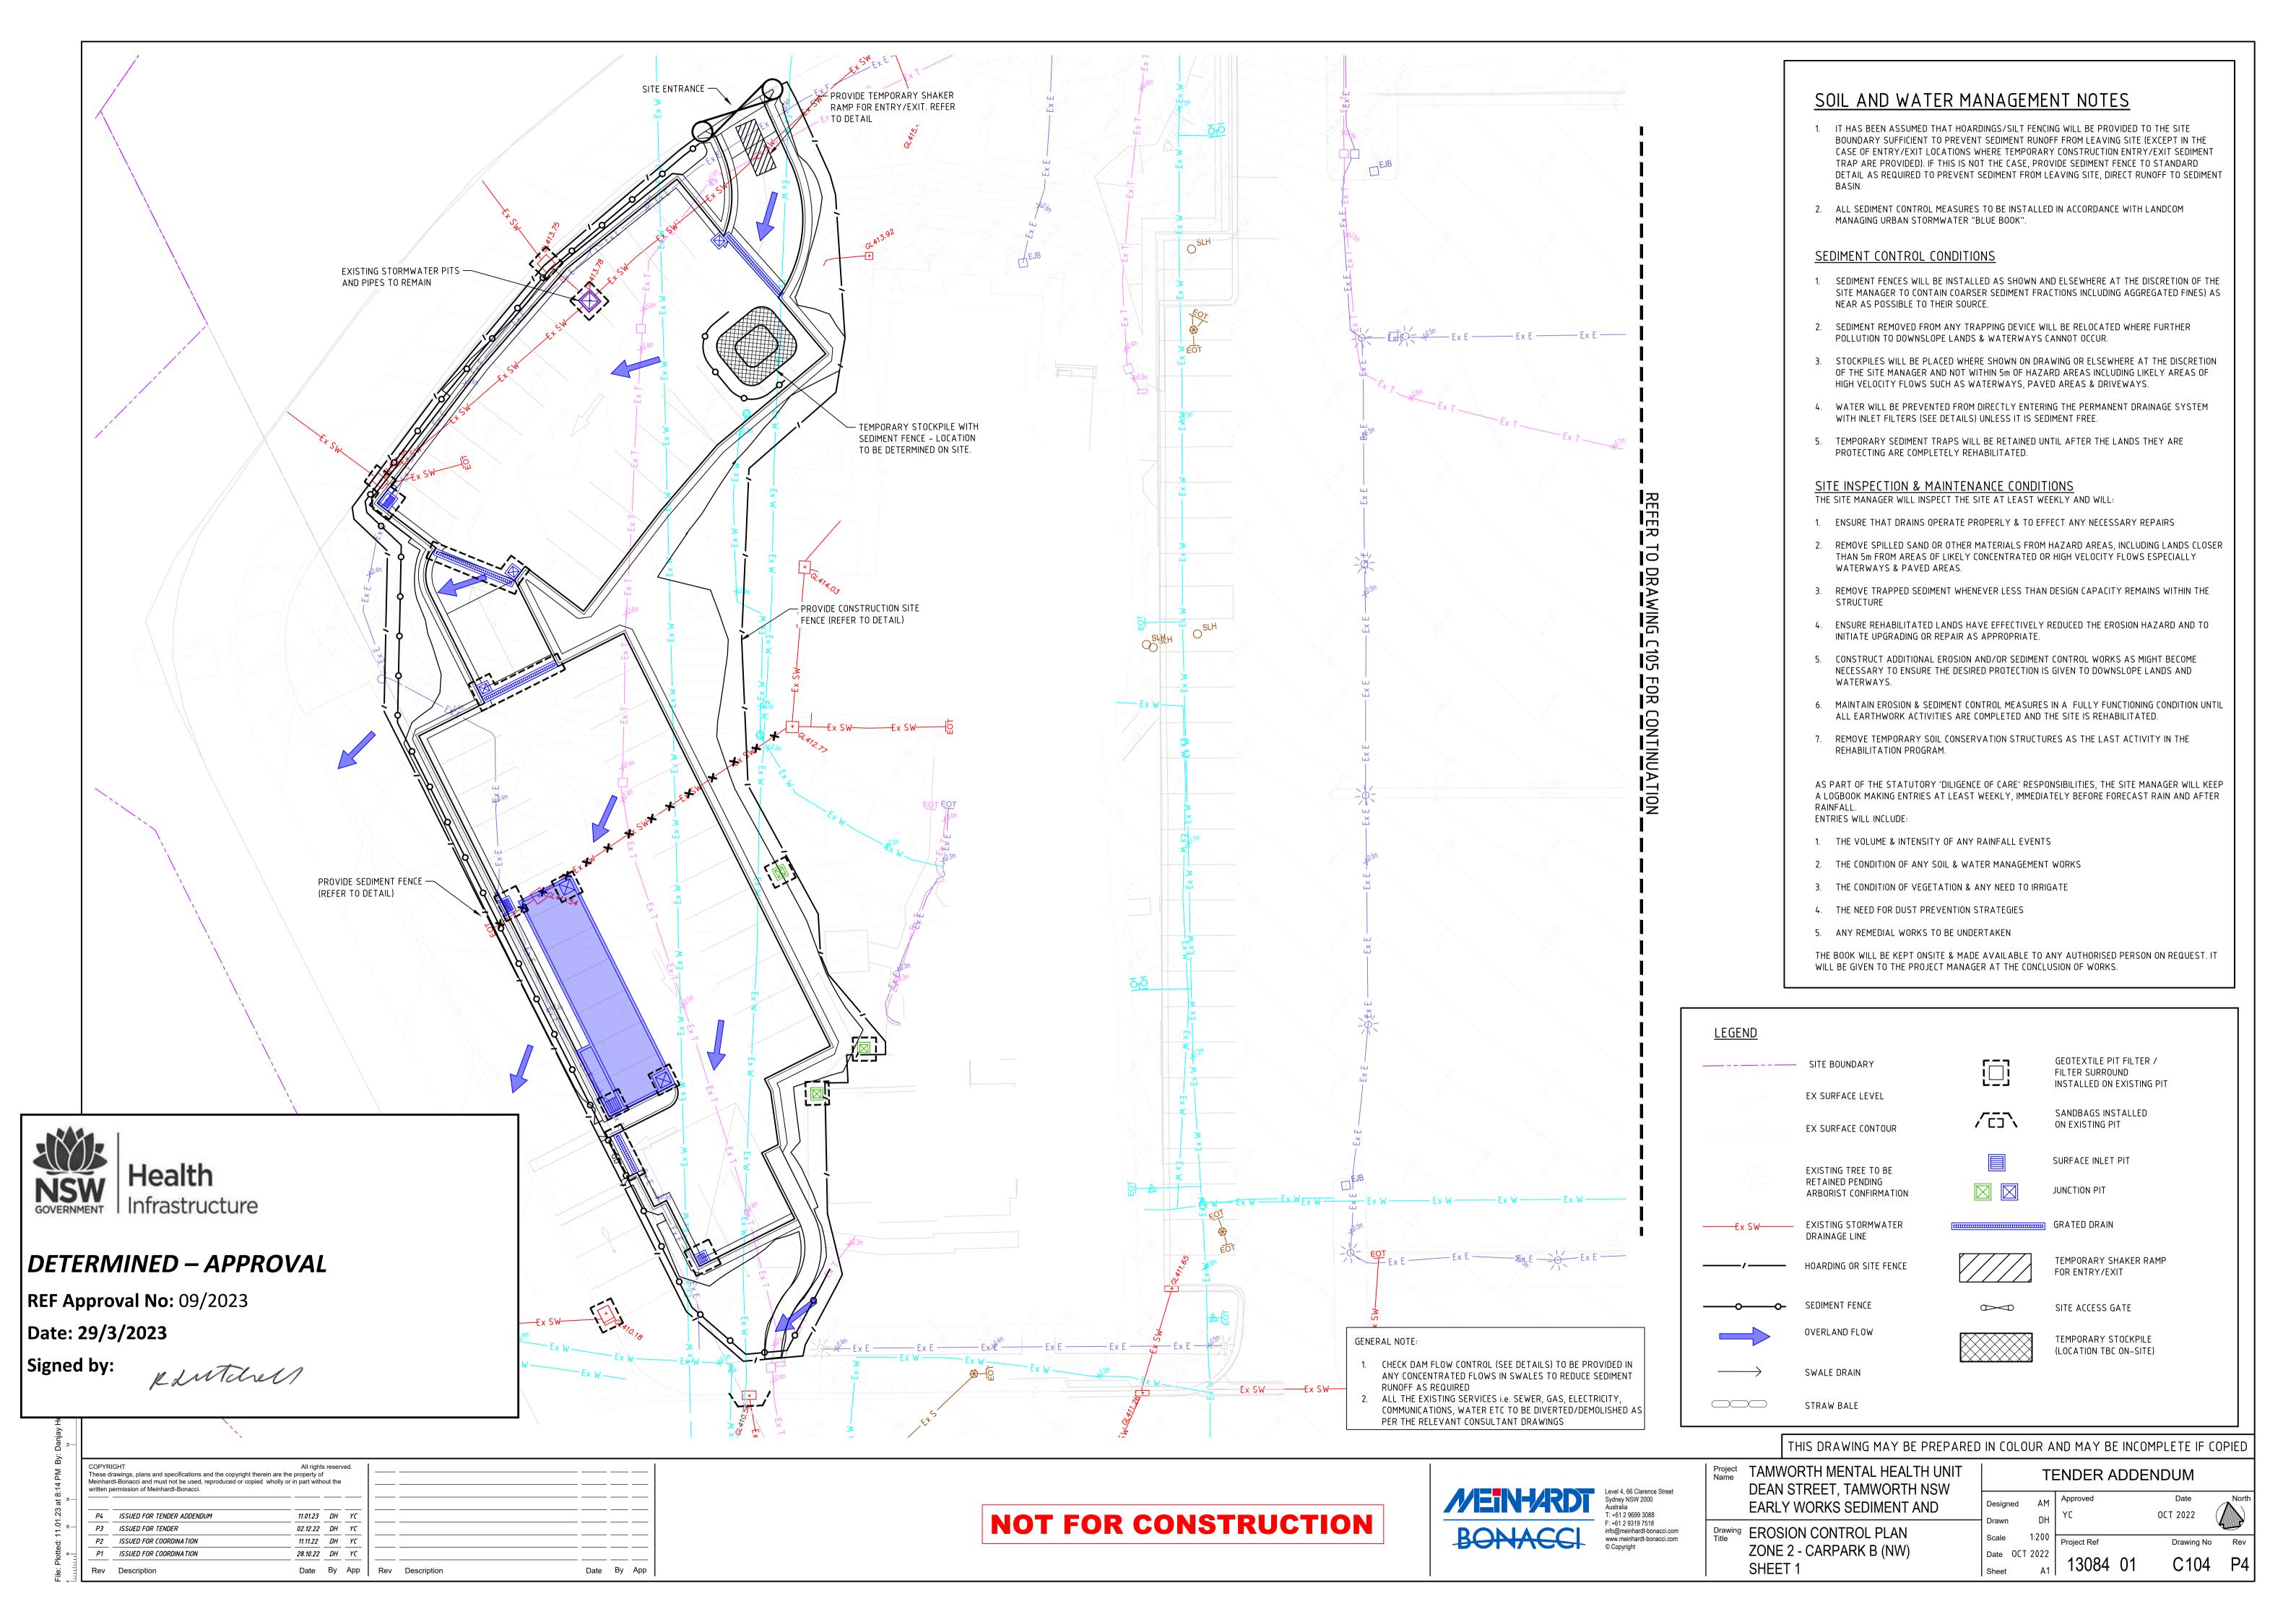SEDIMENT CONTROL CONDITIONS

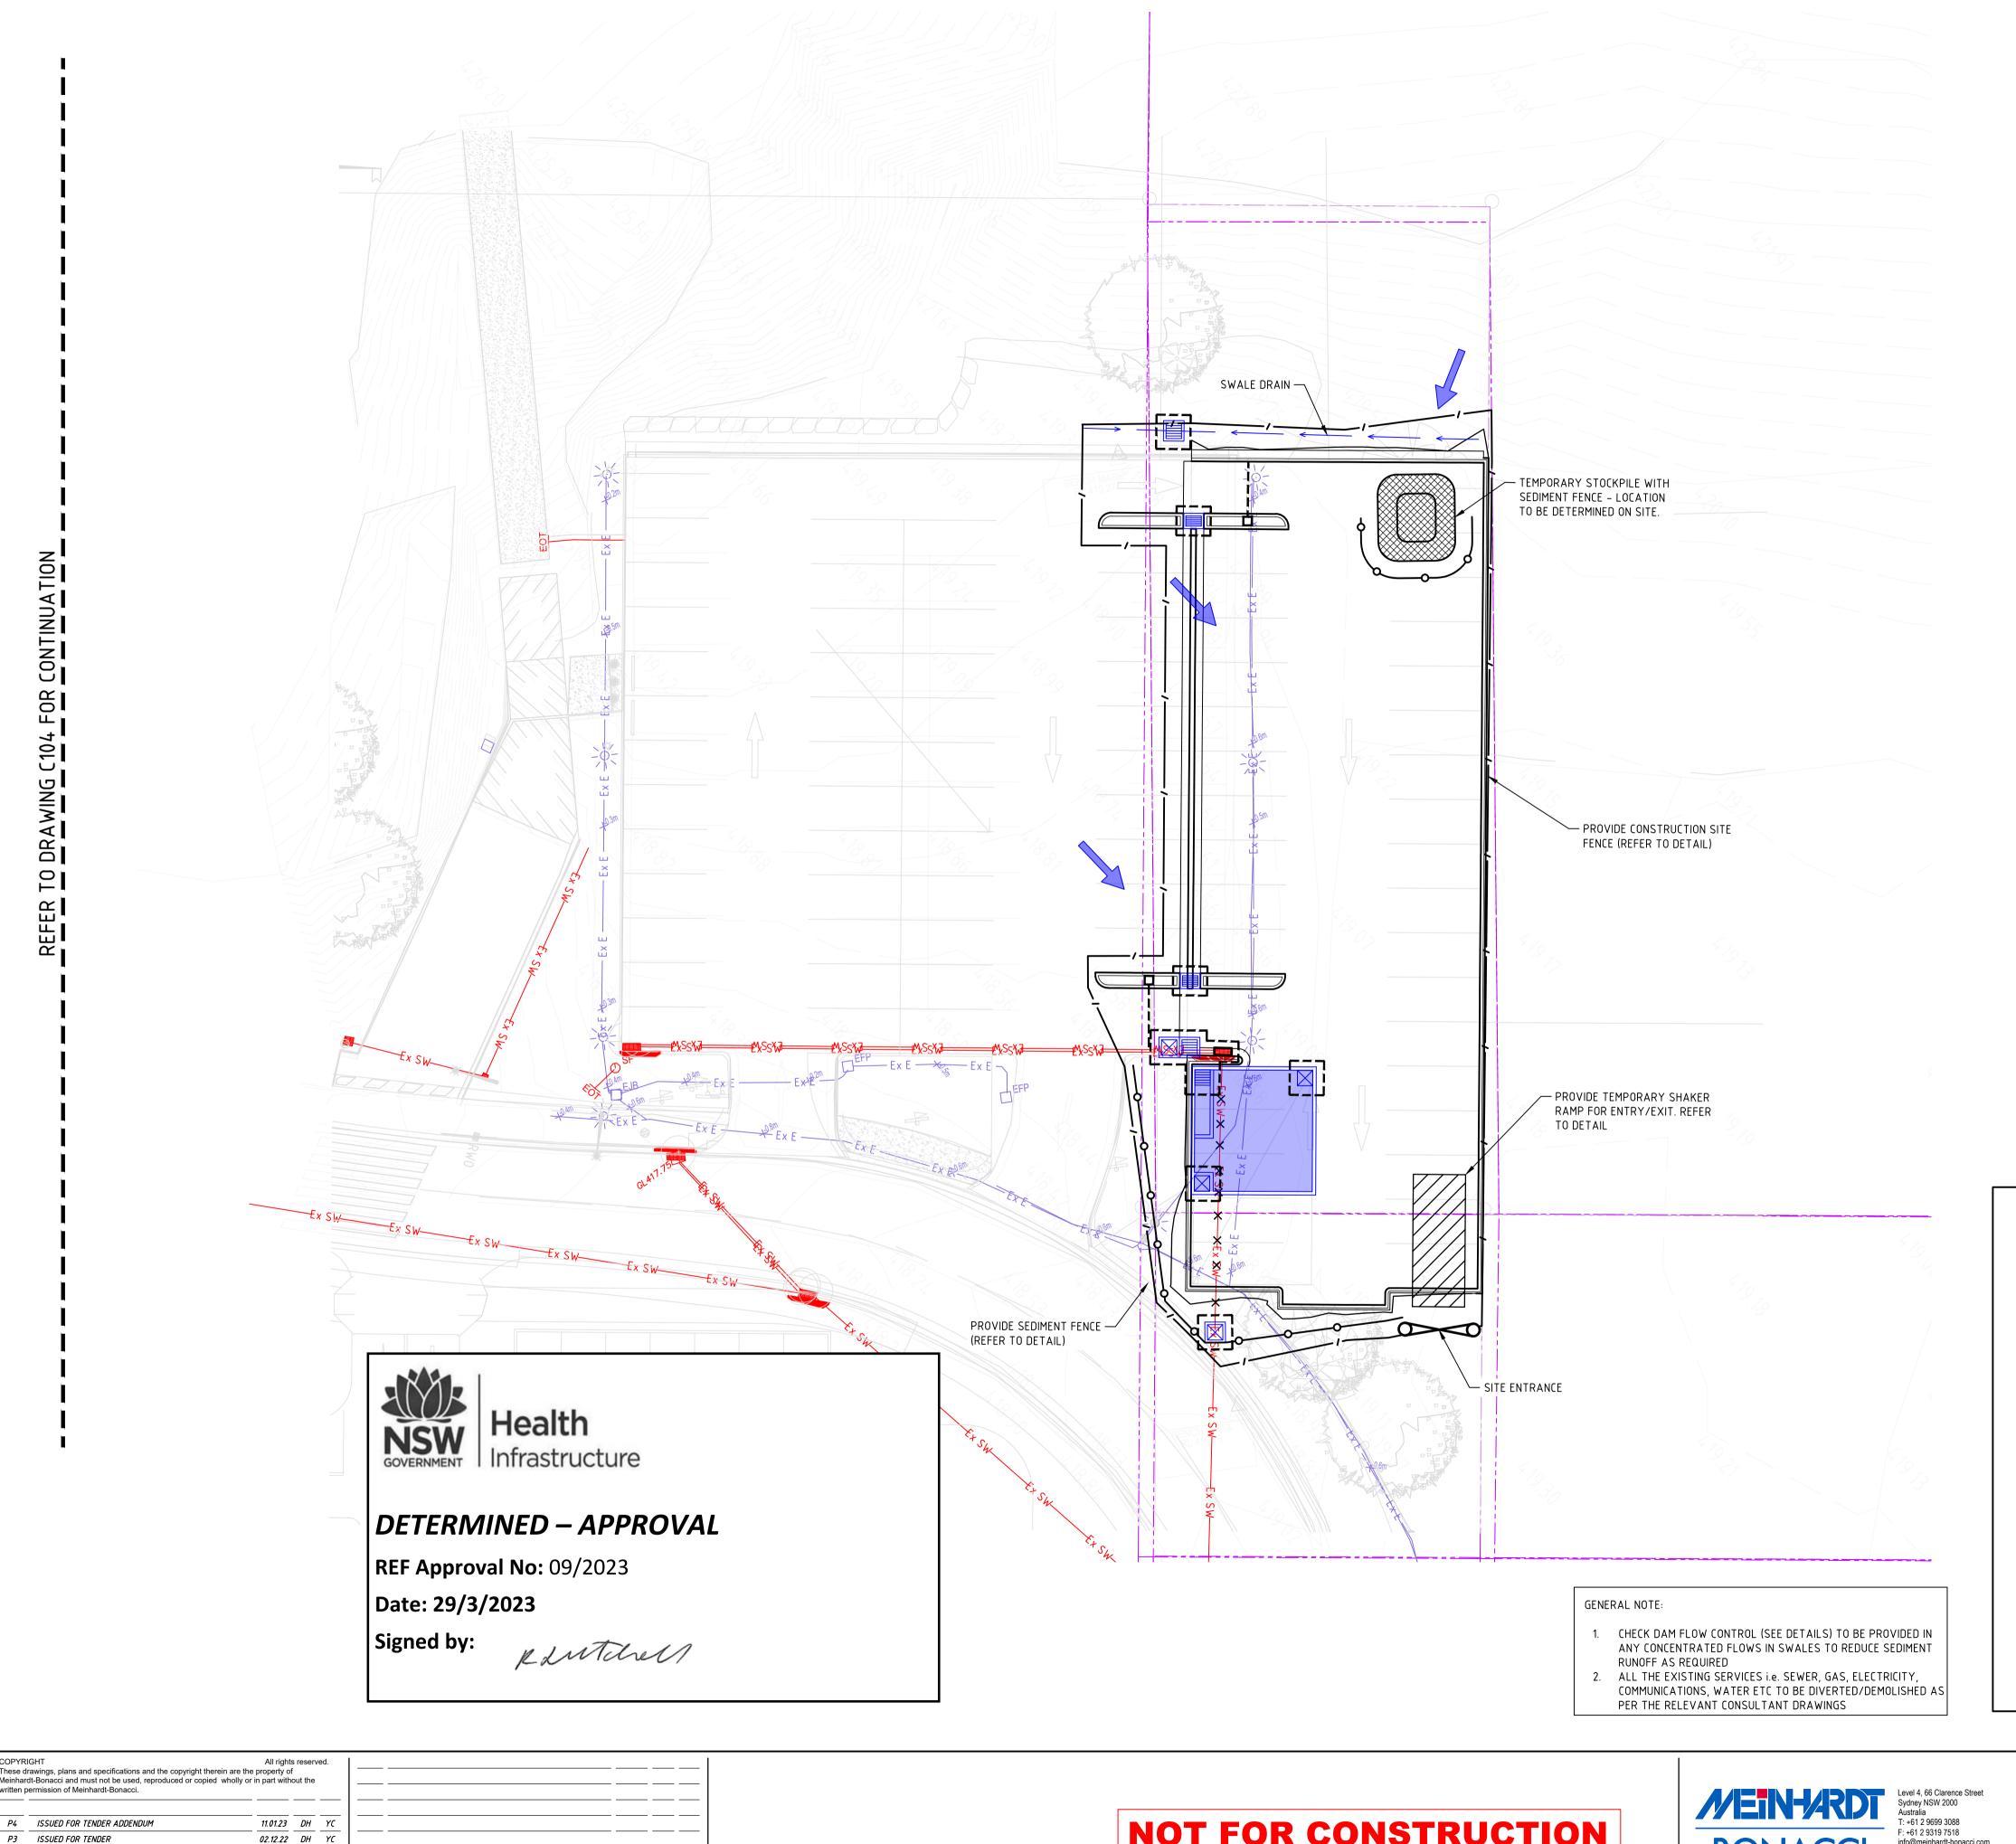- 1. SEDIMENT FENCES WILL BE INSTALLED AS SHOWN AND ELSEWHERE AT THE DISCRETION OF THE SITE MANAGER TO CONTAIN COARSER SEDIMENT FRACTIONS INCLUDING AGGREGATED FINES) AS NEAR AS POSSIBLE TO THEIR SOURCE.
- SEDIMENT REMOVED FROM ANY TRAPPING DEVICE WILL BE RELOCATED WHERE FURTHER POLLUTION TO DOWNSLOPE LANDS & WATERWAYS CANNOT OCCUR.
- 3. STOCKPILES WILL BE PLACED WHERE SHOWN ON DRAWING OR ELSEWHERE AT THE DISCRETION OF THE SITE MANAGER AND NOT WITHIN 5m OF HAZARD AREAS INCLUDING LIKELY AREAS OF HIGH VELOCITY FLOWS SUCH AS WATERWAYS, PAVED AREAS & DRIVEWAYS.
- 4. WATER WILL BE PREVENTED FROM DIRECTLY ENTERING THE PERMANENT DRAINAGE SYSTEM WITH INLET FILTERS (SEE DETAILS) UNLESS IT IS SEDIMENT FREE.
- 5. TEMPORARY SEDIMENT TRAPS WILL BE RETAINED UNTIL AFTER THE LANDS THEY ARE PROTECTING ARE COMPLETELY REHABILITATED.

SITE INSPECTION & MAINTENANCE CONDITIONS

THE SITE MANAGER WILL INSPECT THE SITE AT LEAST WEEKLY AND WILL:

- 1. ENSURE THAT DRAINS OPERATE PROPERLY & TO EFFECT ANY NECESSARY REPAIRS
- 2. REMOVE SPILLED SAND OR OTHER MATERIALS FROM HAZARD AREAS, INCLUDING LANDS CLOSER THAN 5m FROM AREAS OF LIKELY CONCENTRATED OR HIGH VELOCITY FLOWS ESPECIALLY WATERWAYS & PAVED AREAS.
- 3. REMOVE TRAPPED SEDIMENT WHENEVER LESS THAN DESIGN CAPACITY REMAINS WITHIN THE STRUCTURE
- 4. ENSURE REHABILITATED LANDS HAVE EFFECTIVELY REDUCED THE EROSION HAZARD AND TO INITIATE UPGRADING OR REPAIR AS APPROPRIATE.
- CONSTRUCT ADDITIONAL EROSION AND/OR SEDIMENT CONTROL WORKS AS MIGHT BECOME NECESSARY TO ENSURE THE DESIRED PROTECTION IS GIVEN TO DOWNSLOPE LANDS AND
- MAINTAIN EROSION & SEDIMENT CONTROL MEASURES IN A FULLY FUNCTIONING CONDITION UNTIL ALL EARTHWORK ACTIVITIES ARE COMPLETED AND THE SITE IS REHABILITATED.
- REMOVE TEMPORARY SOIL CONSERVATION STRUCTURES AS THE LAST ACTIVITY IN THE REHABILITATION PROGRAM.

AS PART OF THE STATUTORY 'DILIGENCE OF CARE' RESPONSIBILITIES, THE SITE MANAGER WILL KEEP A LOGBOOK MAKING ENTRIES AT LEAST WEEKLY, IMMEDIATELY BEFORE FORECAST RAIN AND AFTER RAINFALL. ENTRIES WILL INCLUDE:

- THE VOLUME & INTENSITY OF ANY RAINFALL EVENTS
- 2. THE CONDITION OF ANY SOIL & WATER MANAGEMENT WORKS 3. THE CONDITION OF VEGETATION & ANY NEED TO IRRIGATE
- 4. THE NEED FOR DUST PREVENTION STRATEGIES
- 5. ANY REMEDIAL WORKS TO BE UNDERTAKEN
- THE BOOK WILL BE KEPT ONSITE & MADE AVAILABLE TO ANY AUTHORISED PERSON ON REQUEST. IT WILL BE GIVEN TO THE PROJECT MANAGER AT THE CONCLUSION OF WORKS.

<u>LEGEND</u> GEOTEXTILE PIT FILTER / _____ - _ _ SITE BOUNDARY FILTER SURROUND INSTALLED ON EXISTING PIT EX SURFACE LEVEL SANDBAGS INSTALLED ON EXISTING PIT EX SURFACE CONTOUR SURFACE INLET PIT EXISTING TREE TO BE RETAINED PENDING JUNCTION PIT ARBORIST CONFIRMATION EXISTING STORMWATER GRATED DRAIN ———Ex SW——— DRAINAGE LINE TEMPORARY SHAKER RAMP HOARDING OR SITE FENCE FOR ENTRY/EXIT SEDIMENT FENCE SITE ACCESS GATE OVERLAND FLOW TEMPORARY STOCKPILE (LOCATION TBC ON-SITE) SWALE DRAIN STRAW BALE

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	DEAN STREET, TAMWORTH NSW
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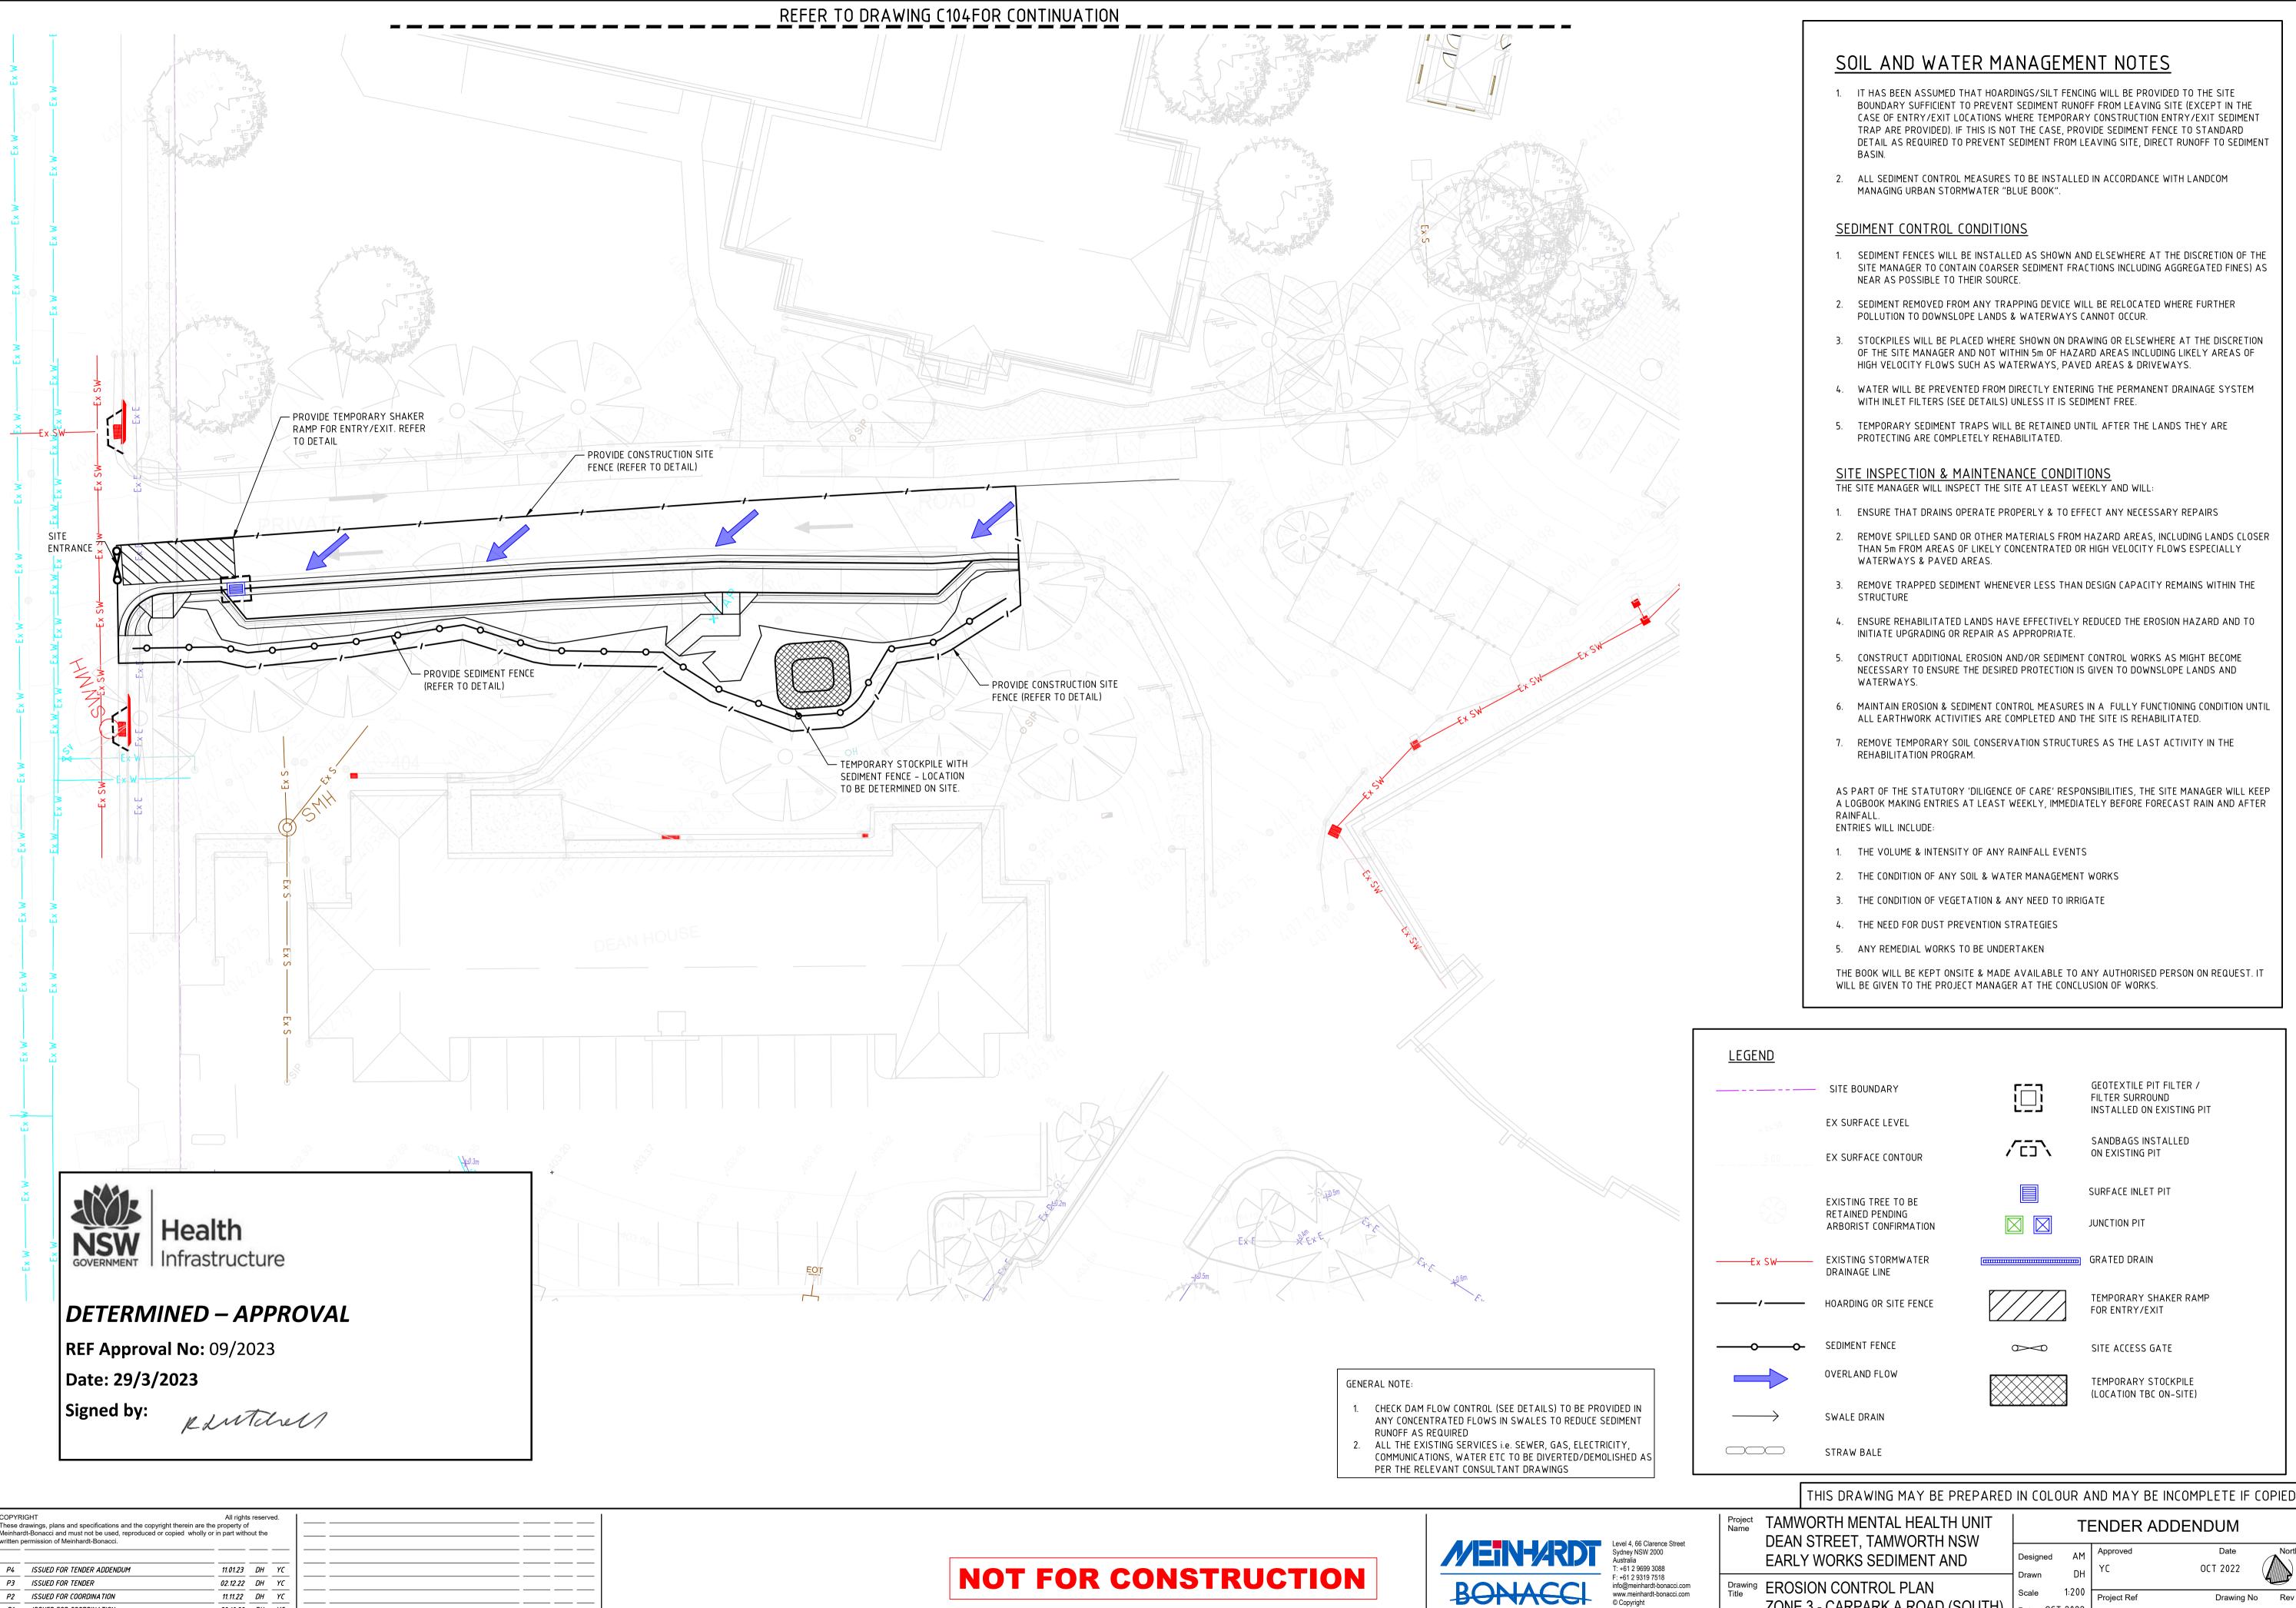
Drawing Title EROSION CONTROL PLAN

SHEET 2

ZONE 1 - CARPARK D (NE)

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rown	DН		OCT 202

Project Ref Drawing No C105 P4



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Drawing EROSION CONTROL PLAN

SHEET 3

ZONE 3 - CARPARK A ROAD (SOUTH)

TENDER ADDENDUM

OCT 2022 Project Ref C106 P4

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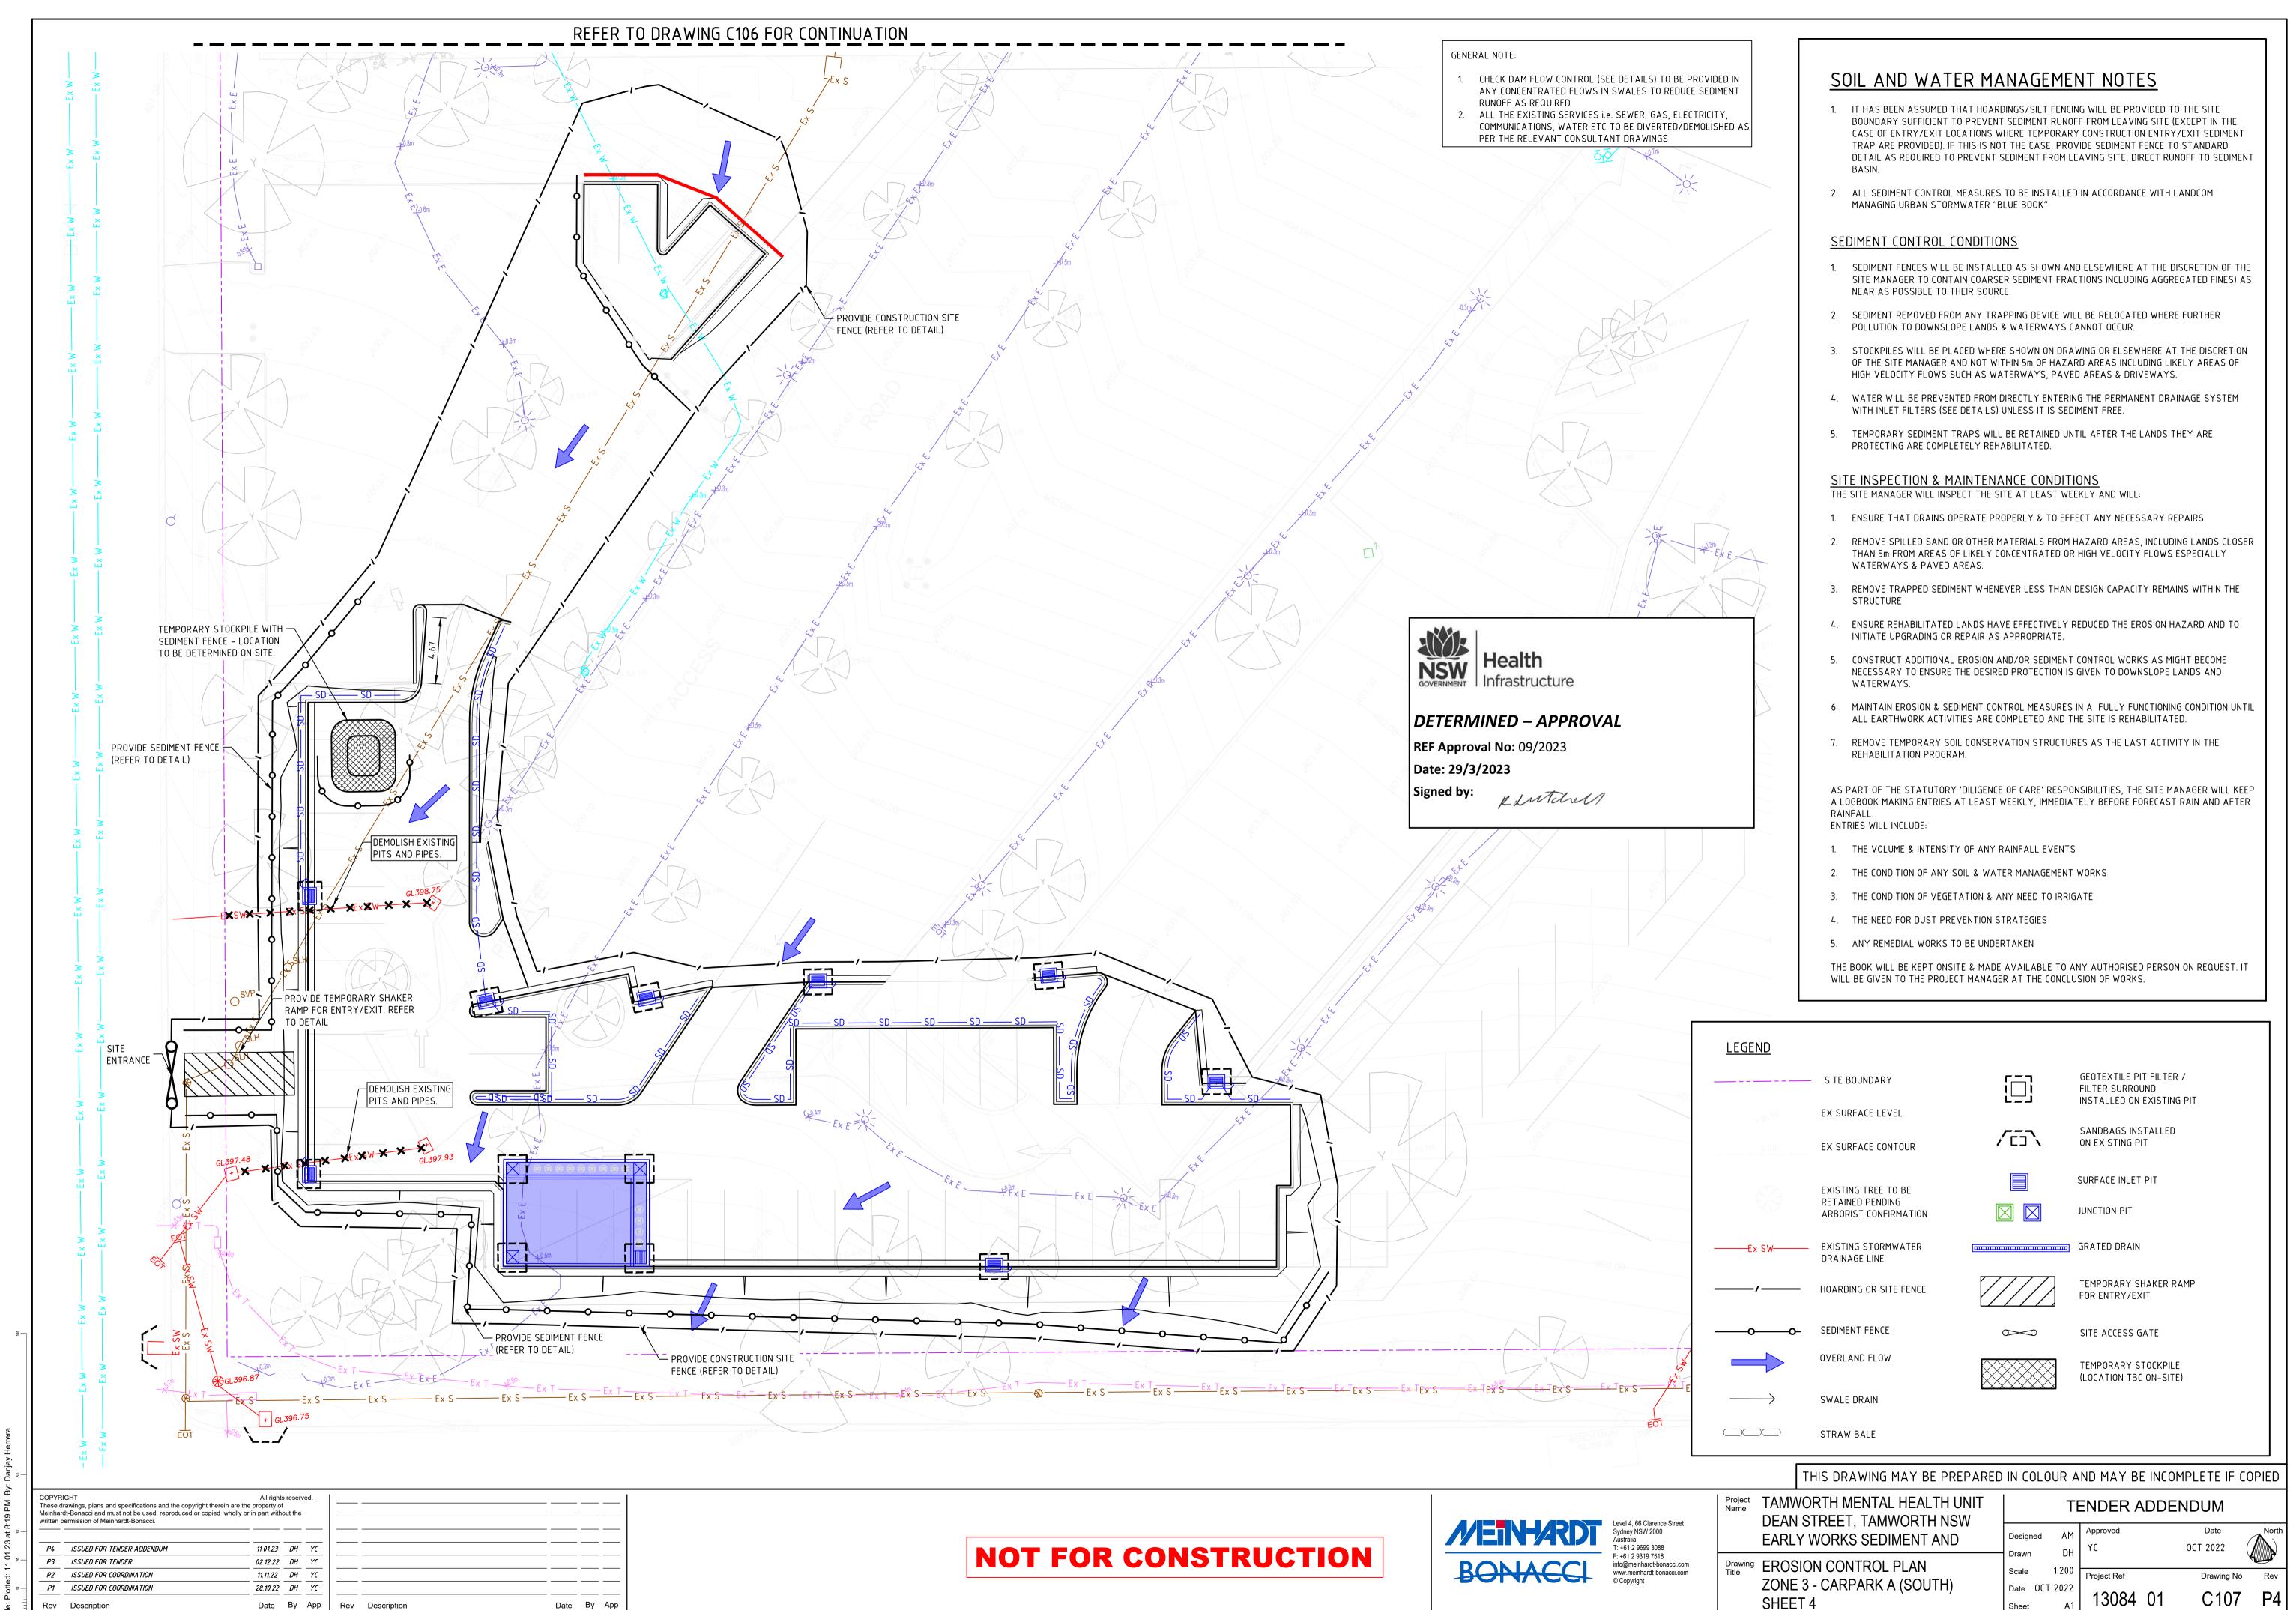
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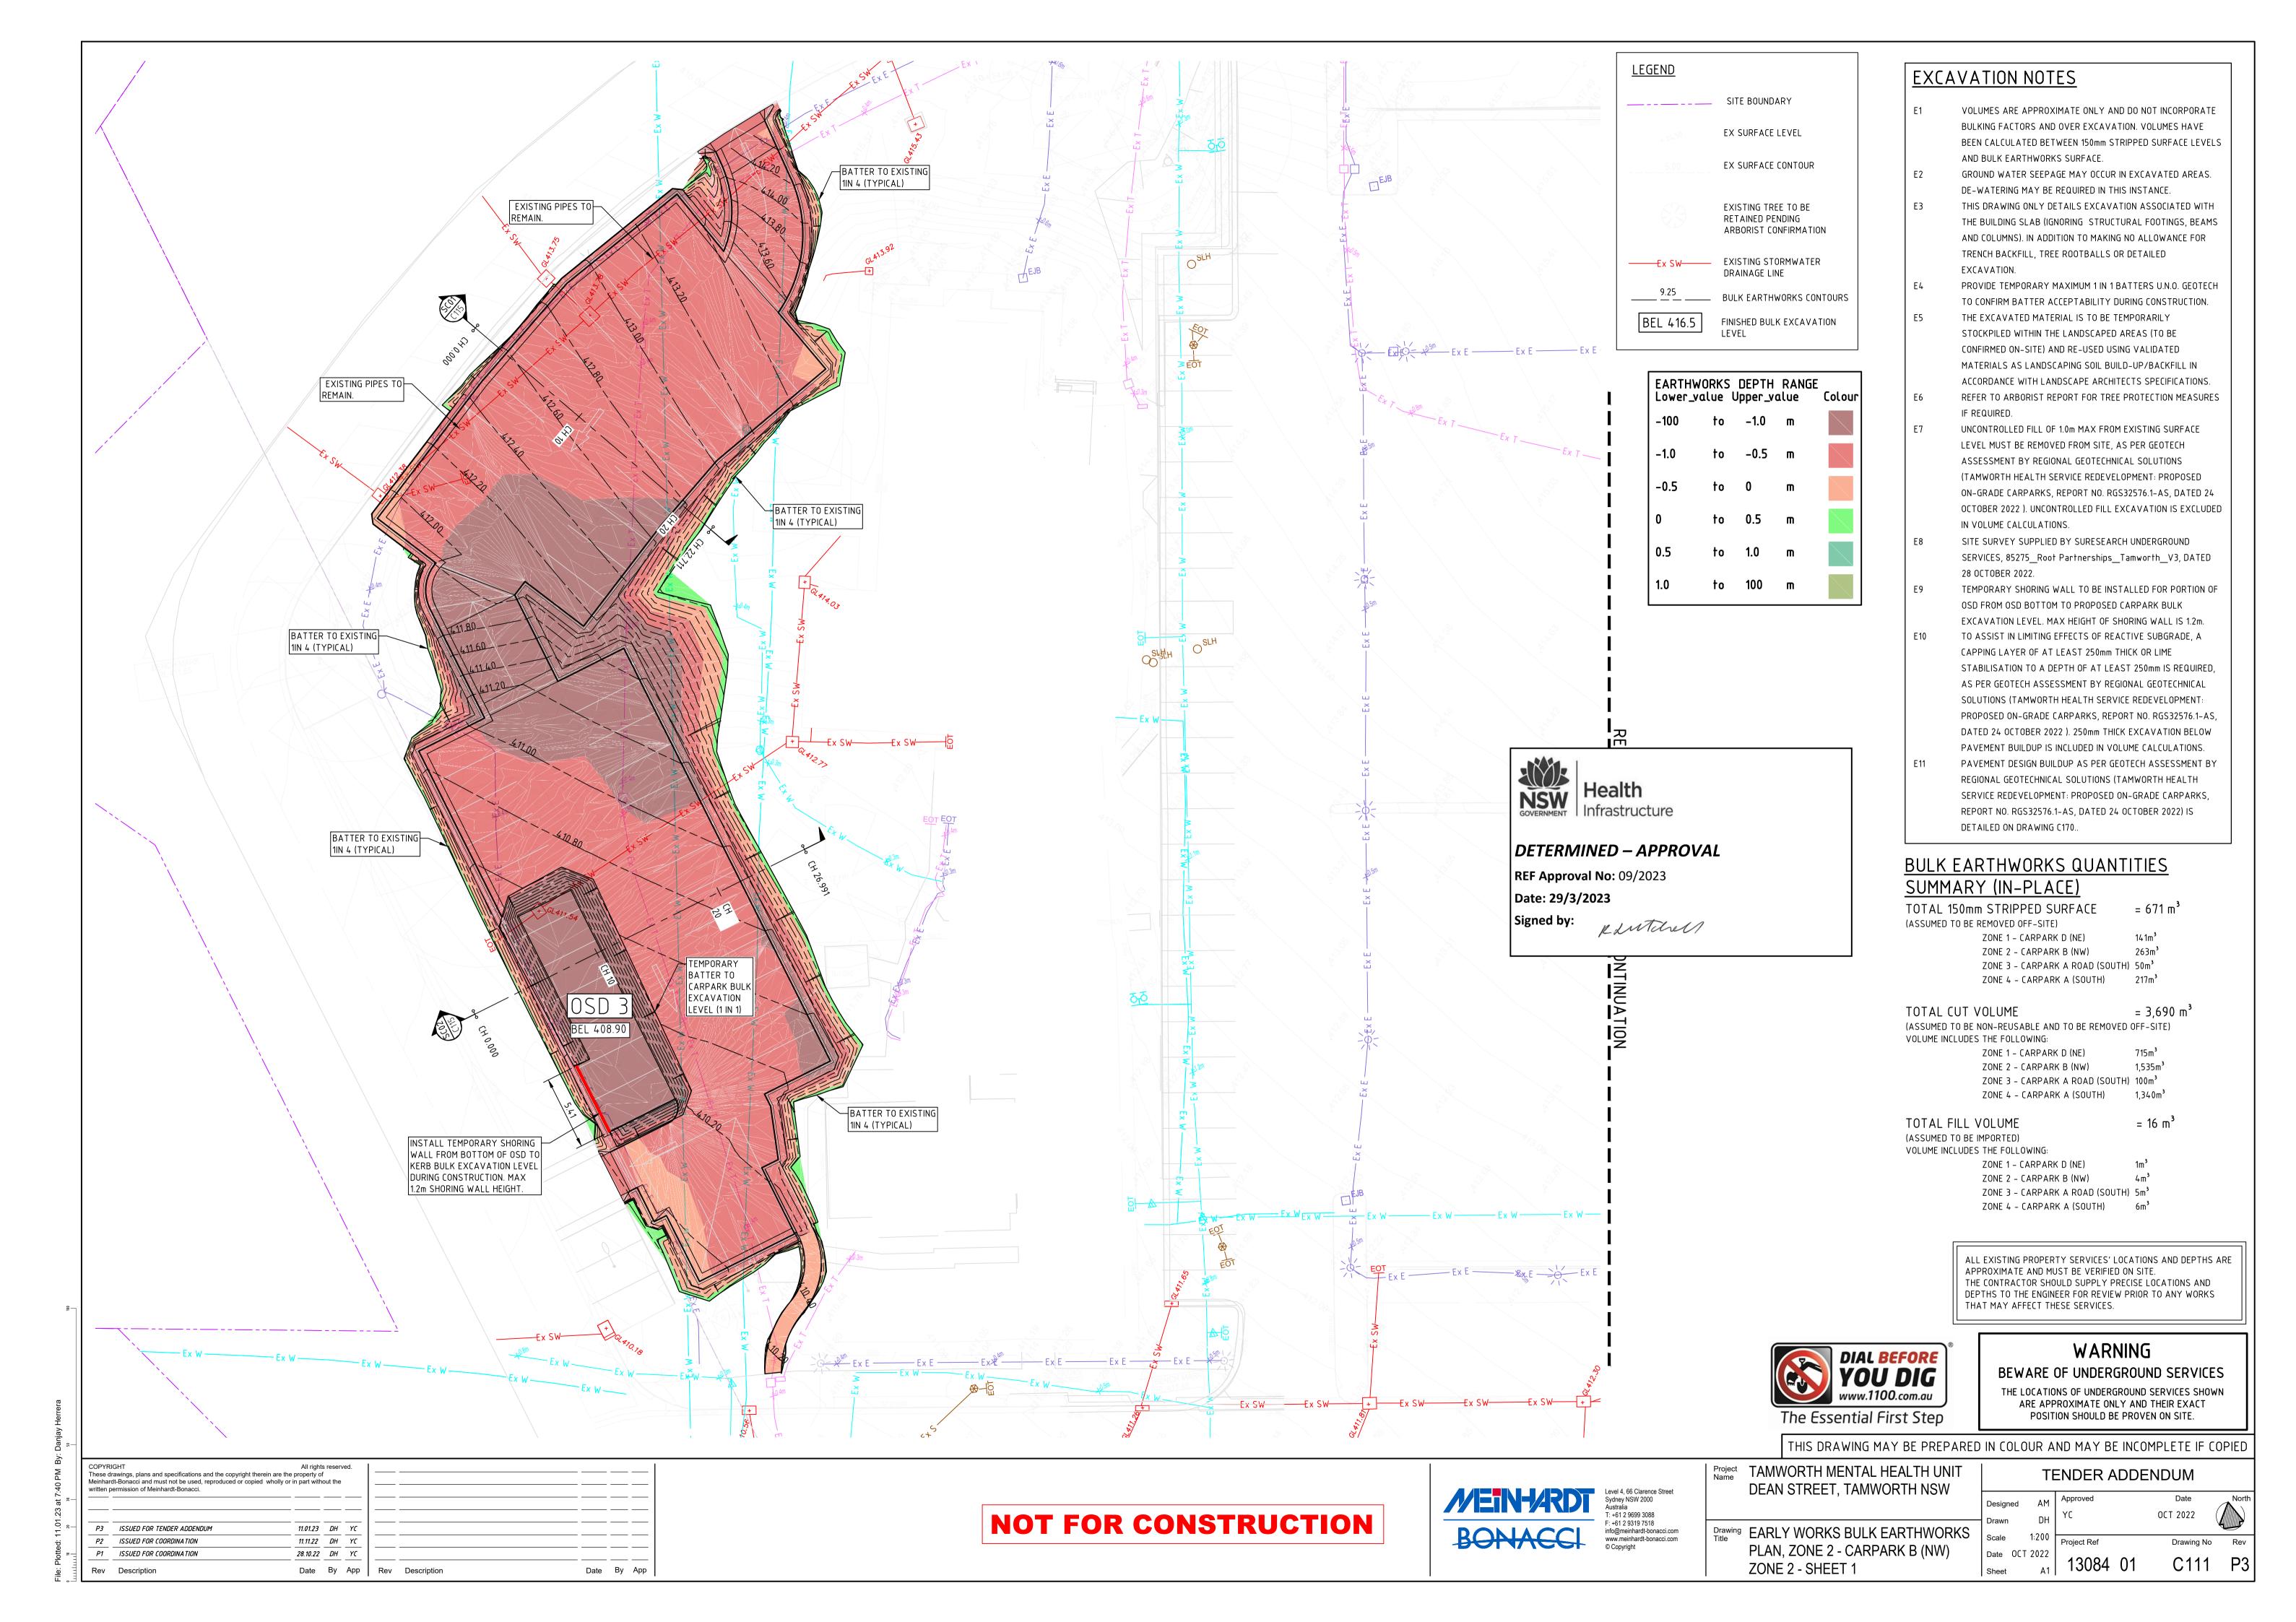
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Rev Description

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SITE BOUNDARY EX SURFACE LEVEL EX SURFACE CONTOUR EXISTING TREE TO BE RETAINED PENDING ARBORIST CONFIRMATION Ex SW——EXISTING STORMWATER DRAINAGE LINE BULK EARTHWORKS CONTOURS FINISHED BULK EXCAVATION

> EARTHWORKS DEPTH RANGE Lower_value Upper_value Colour 0.5

EXCAVATION NOTES

- VOLUMES ARE APPROXIMATE ONLY AND DO NOT INCORPORATE BULKING FACTORS AND OVER EXCAVATION. VOLUMES HAVE BEEN CALCULATED BETWEEN 150mm STRIPPED SURFACE LEVELS
- AND BULK EARTHWORKS SURFACE. E2 GROUND WATER SEEPAGE MAY OCCUR IN EXCAVATED AREAS. DE-WATERING MAY BE REQUIRED IN THIS INSTANCE.
 - THIS DRAWING ONLY DETAILS EXCAVATION ASSOCIATED WITH THE BUILDING SLAB (IGNORING STRUCTURAL FOOTINGS, BEAMS AND COLUMNS). IN ADDITION TO MAKING NO ALLOWANCE FOR TRENCH BACKFILL, TREE ROOTBALLS OR DETAILED EXCAVATION.
 - PROVIDE TEMPORARY MAXIMUM 1 IN 1 BATTERS U.N.O. GEOTECH TO CONFIRM BATTER ACCEPTABILITY DURING CONSTRUCTION.

THE EXCAVATED MATERIAL IS TO BE TEMPORARILY

- STOCKPILED WITHIN THE LANDSCAPED AREAS (TO BE CONFIRMED ON-SITE) AND RE-USED USING VALIDATED MATERIALS AS LANDSCAPING SOIL BUILD-UP/BACKFILL IN ACCORDANCE WITH LANDSCAPE ARCHITECTS SPECIFICATIONS. REFER TO ARBORIST REPORT FOR TREE PROTECTION MEASURES
- UNCONTROLLED FILL OF 1.0m MAX FROM EXISTING SURFACE LEVEL MUST BE REMOVED FROM SITE, AS PER GEOTECH ASSESSMENT BY REGIONAL GEOTECHNICAL SOLUTIONS (TAMWORTH HEALTH SERVICE REDEVELOPMENT: PROPOSED

ON-GRADE CARPARKS, REPORT NO. RGS32576.1-AS, DATED 24

OCTOBER 2022). UNCONTROLLED FILL EXCAVATION IS EXCLUDED

- IN VOLUME CALCULATIONS. SITE SURVEY SUPPLIED BY SURESEARCH UNDERGROUND SERVICES, 85275_Root Partnerships_Tamworth_V3, DATED
- 28 OCTOBER 2022. TEMPORARY SHORING WALL TO BE INSTALLED FOR PORTION OF ZONE 2 OSD FROM OSD BOTTOM TO PROPOSED CARPARK BULK EXCAVATION LEVEL. MAX HEIGHT OF SHORING WALL IS 1.2m.
- TO ASSIST IN LIMITING EFFECTS OF REACTIVE SUBGRADE, A CAPPING LAYER OF AT LEAST 250mm THICK OR LIME STABILISATION TO A DEPTH OF AT LEAST 250mm IS REQUIRED, AS PER GEOTECH ASSESSMENT BY REGIONAL GEOTECHNICAL SOLUTIONS (TAMWORTH HEALTH SERVICE REDEVELOPMENT: PROPOSED ON-GRADE CARPARKS, REPORT NO. RGS32576.1-AS, DATED 24 OCTOBER 2022). 250mm THICK EXCAVATION BELOW

PAVEMENT BUILDUP IS INCLUDED IN VOLUME CALCULATIONS.

PAVEMENT DESIGN BUILDUP AS PER GEOTECH ASSESSMENT BY REGIONAL GEOTECHNICAL SOLUTIONS (TAMWORTH HEALTH SERVICE REDEVELOPMENT: PROPOSED ON-GRADE CARPARKS, REPORT NO. RGS32576.1-AS, DATED 24 OCTOBER 2022) IS DETAILED ON DRAWING C170.

BULK EARTHWORKS QUANTITIES

SUMMARY (IN-PLACE)

TOTAL 150mm STRIPPED SURFACE = 671 m³ (ASSUMED TO BE REMOVED OFF-SITE) ZONE 1 – CARPARK D (NE) 141m³

263m³ ZONE 2 – CARPARK B (NW) ZONE 3 - CARPARK A ROAD (SOUTH) 50m³ ZONE 4 - CARPARK A (SOUTH)

 $= 3,690 \text{ m}^3$ TOTAL CUT VOLUME (ASSUMED TO BE NON-REUSABLE AND TO BE REMOVED OFF-SITE) VOLUME INCLUDES THE FOLLOWING: ZONE 1 – CARPARK D (NE) 715m³

ZONE 2 – CARPARK B (NW) 1,535m³ ZONE 3 - CARPARK A ROAD (SOUTH) 100m³ ZONE 4 - CARPARK A (SOUTH)

TOTAL FILL VOLUME (ASSUMED TO BE IMPORTED) VOLUME INCLUDES THE FOLLOWING:

ZONE 1 – CARPARK D (NE) ZONE 2 - CARPARK B (NW)

ZONE 3 - CARPARK A ROAD (SOUTH) 5m3 ZONE 4 – CARPARK A (SOUTH)

ALL EXISTING PROPERTY SERVICES' LOCATIONS AND DEPTHS ARE APPROXIMATE AND MUST BE VERIFIED ON SITE. THE CONTRACTOR SHOULD SUPPLY PRECISE LOCATIONS AND DEPTHS TO THE ENGINEER FOR REVIEW PRIOR TO ANY WORKS THAT MAY AFFECT THESE SERVICES.



WARNING

= 16 m³

BEWARE OF UNDERGROUND SERVICES THE LOCATIONS OF UNDERGROUND SERVICES SHOWN

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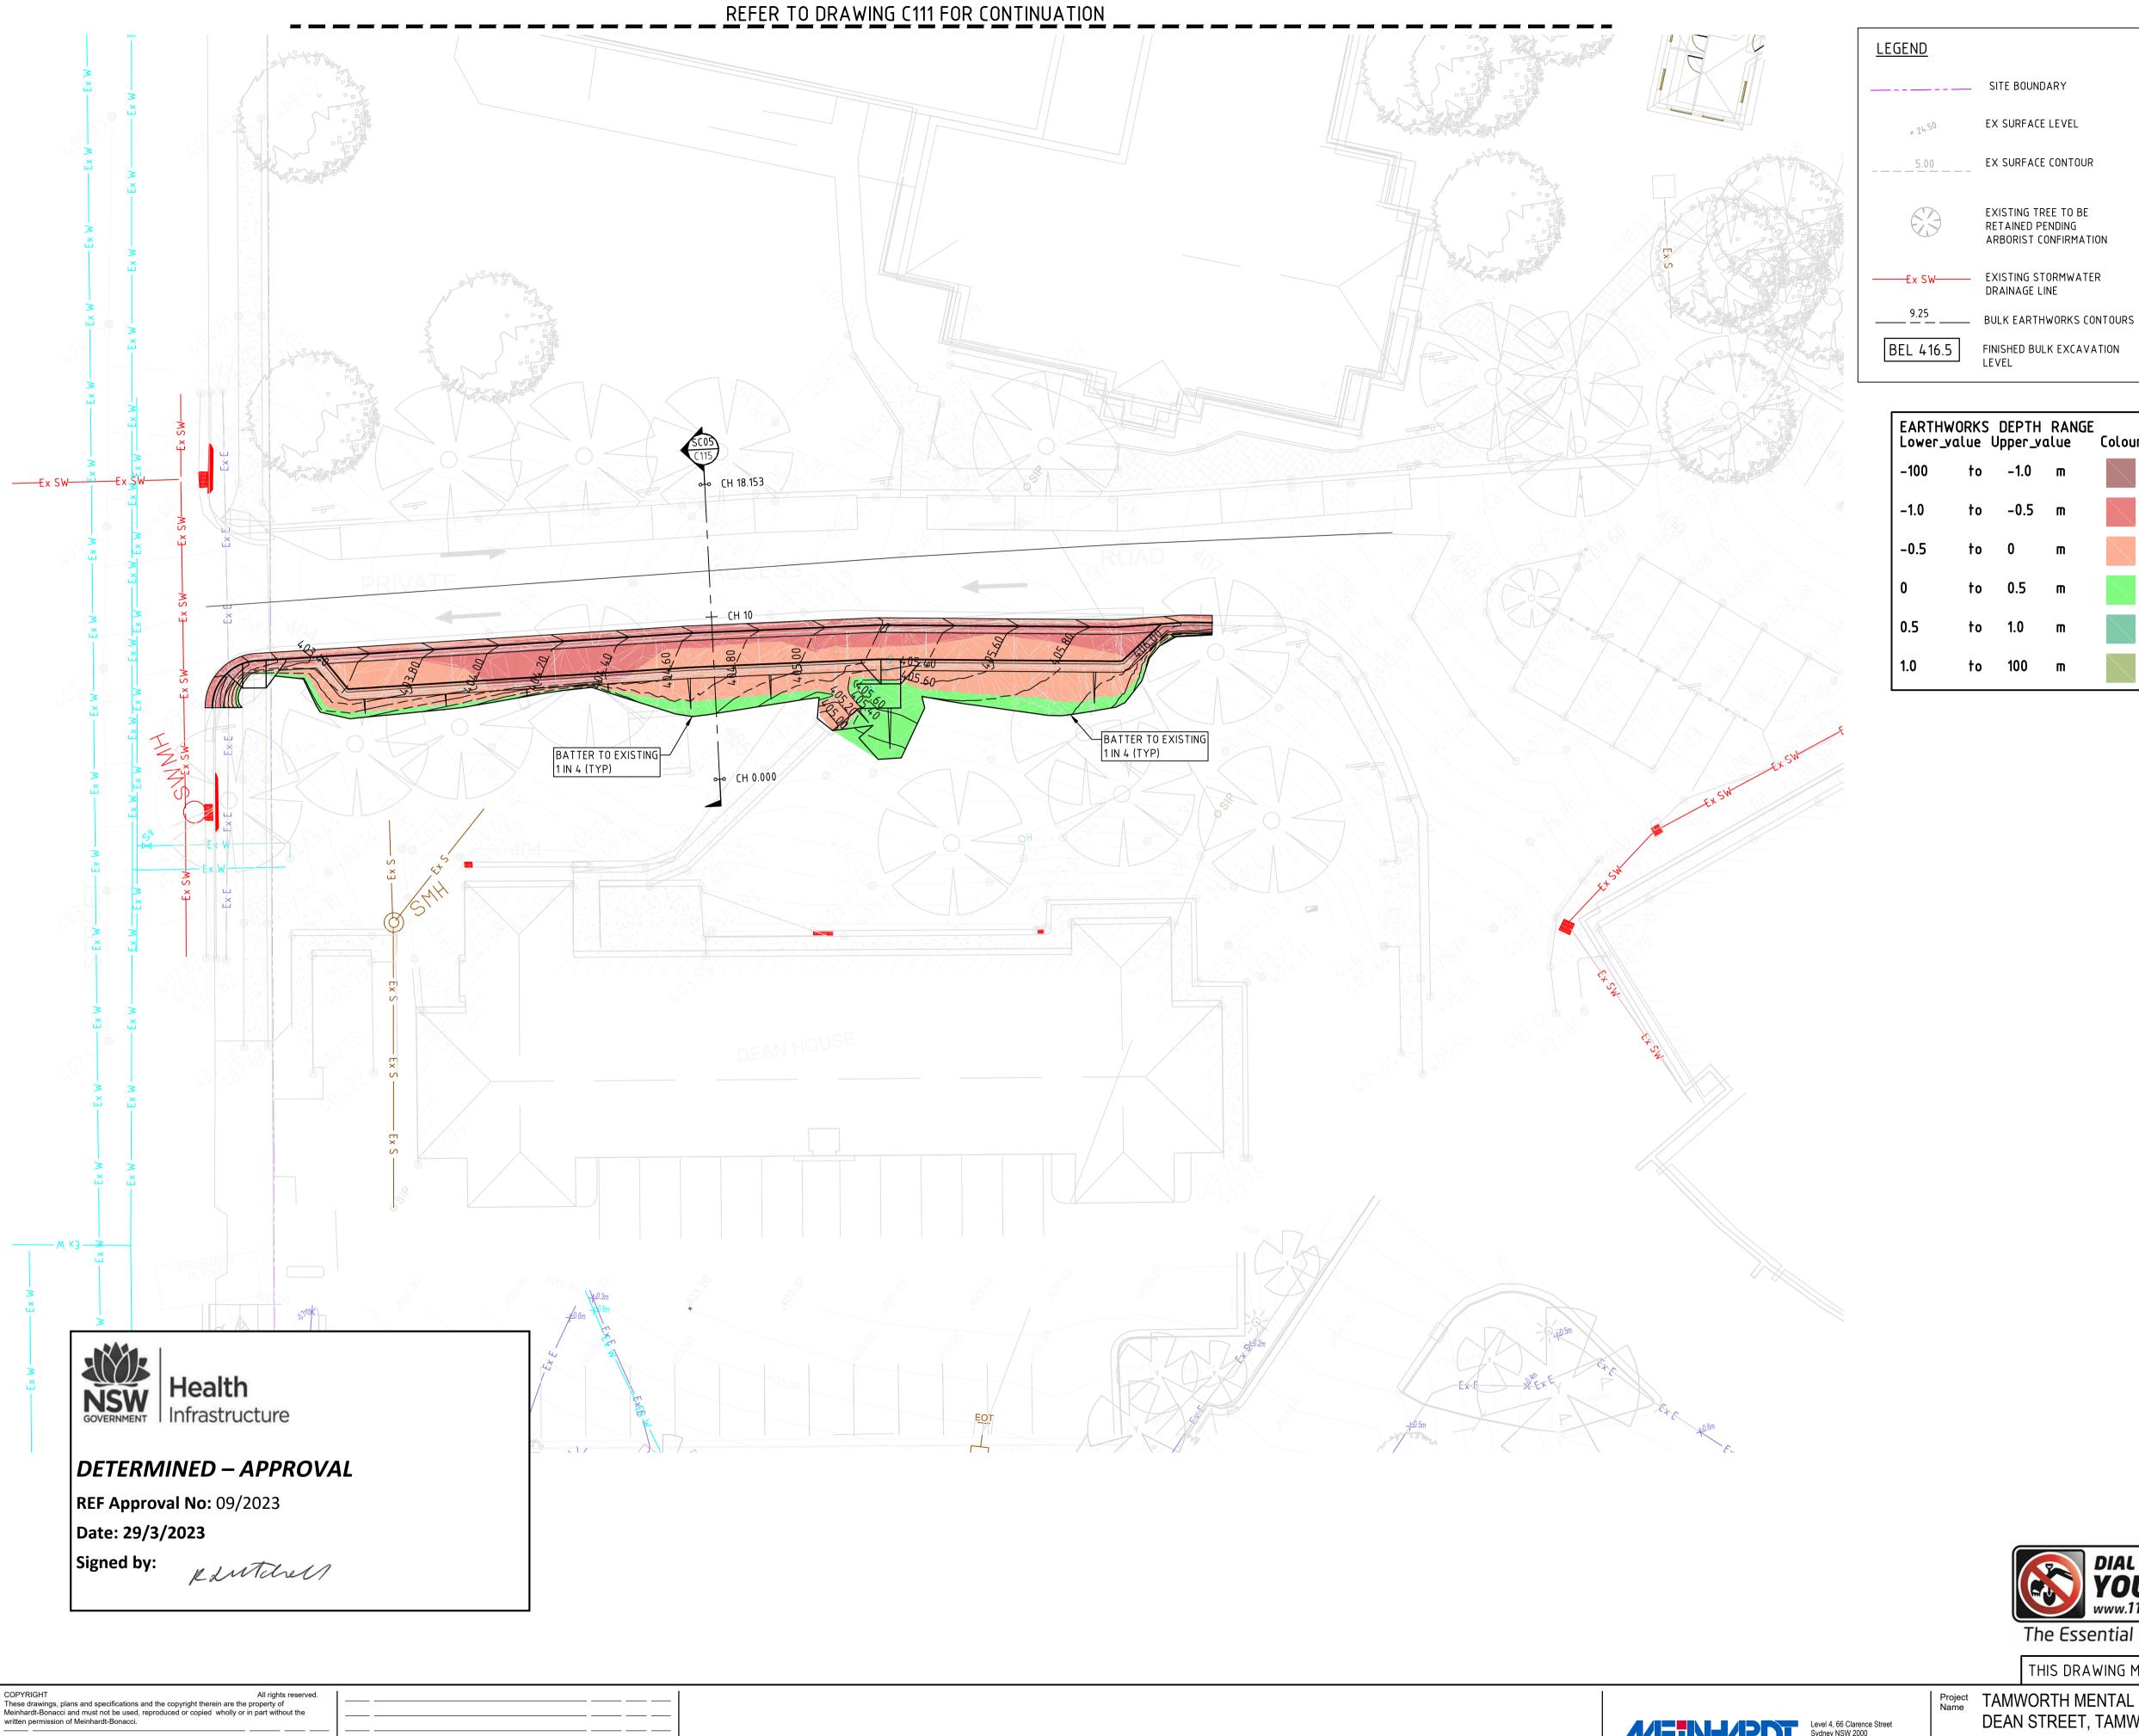


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Drawing Title EARLY WORKS BULK EARTHWORKS PLAN, ZONE 1 - CARPARK D (NE) SHEET 2

TENDER ADDENDUM

OCT 2022 Project Ref Drawing No 13084 01 C112 P3



EXCAVATION NOTES

IF REQUIRED.

Colour

VOLUMES ARE APPROXIMATE ONLY AND DO NOT INCORPORATE BULKING FACTORS AND OVER EXCAVATION. VOLUMES HAVE BEEN CALCULATED BETWEEN 150mm STRIPPED SURFACE LEVELS

AND BULK EARTHWORKS SURFACE. GROUND WATER SEEPAGE MAY OCCUR IN EXCAVATED AREAS. E2 DE-WATERING MAY BE REQUIRED IN THIS INSTANCE.

> THIS DRAWING ONLY DETAILS EXCAVATION ASSOCIATED WITH THE BUILDING SLAB (IGNORING STRUCTURAL FOOTINGS, BEAMS AND COLUMNS). IN ADDITION TO MAKING NO ALLOWANCE FOR TRENCH BACKFILL, TREE ROOTBALLS OR DETAILED EXCAVATION.

PROVIDE TEMPORARY MAXIMUM 1 IN 1 BATTERS U.N.O. GEOTECH TO CONFIRM BATTER ACCEPTABILITY DURING CONSTRUCTION.

THE EXCAVATED MATERIAL IS TO BE TEMPORARILY

STOCKPILED WITHIN THE LANDSCAPED AREAS (TO BE CONFIRMED ON-SITE) AND RE-USED USING VALIDATED MATERIALS AS LANDSCAPING SOIL BUILD-UP/BACKFILL IN ACCORDANCE WITH LANDSCAPE ARCHITECTS SPECIFICATIONS. REFER TO ARBORIST REPORT FOR TREE PROTECTION MEASURES

UNCONTROLLED FILL OF 1.0m MAX FROM EXISTING SURFACE LEVEL MUST BE REMOVED FROM SITE, AS PER GEOTECH ASSESSMENT BY REGIONAL GEOTECHNICAL SOLUTIONS (TAMWORTH HEALTH SERVICE REDEVELOPMENT: PROPOSED ON-GRADE CARPARKS, REPORT NO. RGS32576.1-AS, DATED 24 OCTOBER 2022). UNCONTROLLED FILL EXCAVATION IS EXCLUDED IN VOLUME CALCULATIONS.

SITE SURVEY SUPPLIED BY SURESEARCH UNDERGROUND SERVICES, 85275_Root Partnerships_Tamworth_V3, DATED 28 OCTOBER 2022.

TEMPORARY SHORING WALL TO BE INSTALLED FOR PORTION OF ZONE 2 OSD FROM OSD BOTTOM TO PROPOSED CARPARK BULK EXCAVATION LEVEL. MAX HEIGHT OF SHORING WALL IS 1.2m. TO ASSIST IN LIMITING EFFECTS OF REACTIVE SUBGRADE, A CAPPING LAYER OF AT LEAST 250mm THICK OR LIME

STABILISATION TO A DEPTH OF AT LEAST 250mm IS REQUIRED, AS PER GEOTECH ASSESSMENT BY REGIONAL GEOTECHNICAL SOLUTIONS (TAMWORTH HEALTH SERVICE REDEVELOPMENT: PROPOSED ON-GRADE CARPARKS, REPORT NO. RGS32576.1-AS, DATED 24 OCTOBER 2022). 250mm THICK EXCAVATION BELOW PAVEMENT BUILDUP IS INCLUDED IN VOLUME CALCULATIONS.

PAVEMENT DESIGN BUILDUP AS PER GEOTECH ASSESSMENT BY REGIONAL GEOTECHNICAL SOLUTIONS (TAMWORTH HEALTH SERVICE REDEVELOPMENT: PROPOSED ON-GRADE CARPARKS, REPORT NO. RGS32576.1-AS, DATED 24 OCTOBER 2022) IS DETAILED ON DRAWING C170.

BULK EARTHWORKS QUANTITIES

SUMMARY (IN-PLACE)

TOTAL 150mm STRIPPED SURFACE

= 671 m³ (ASSUMED TO BE REMOVED OFF-SITE) ZONE 1 – CARPARK D (NE) 141m³

263m³ ZONE 2 – CARPARK B (NW) ZONE 3 - CARPARK A ROAD (SOUTH) 50m³ ZONE 4 - CARPARK A (SOUTH)

TOTAL CUT VOLUME $= 3,690 \text{ m}^3$ (ASSUMED TO BE NON-REUSABLE AND TO BE REMOVED OFF-SITE) VOLUME INCLUDES THE FOLLOWING:

ZONE 1 – CARPARK D (NE) ZONE 2 – CARPARK B (NW) 1,535m³

ZONE 3 - CARPARK A ROAD (SOUTH) 100m³ ZONE 4 - CARPARK A (SOUTH)

TOTAL FILL VOLUME (ASSUMED TO BE IMPORTED) VOLUME INCLUDES THE FOLLOWING:

ZONE 1 – CARPARK D (NE) ZONE 2 – CARPARK B (NW)

ZONE 3 - CARPARK A ROAD (SOUTH) 5m3 ZONE 4 - CARPARK A (SOUTH)

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= 16 m³

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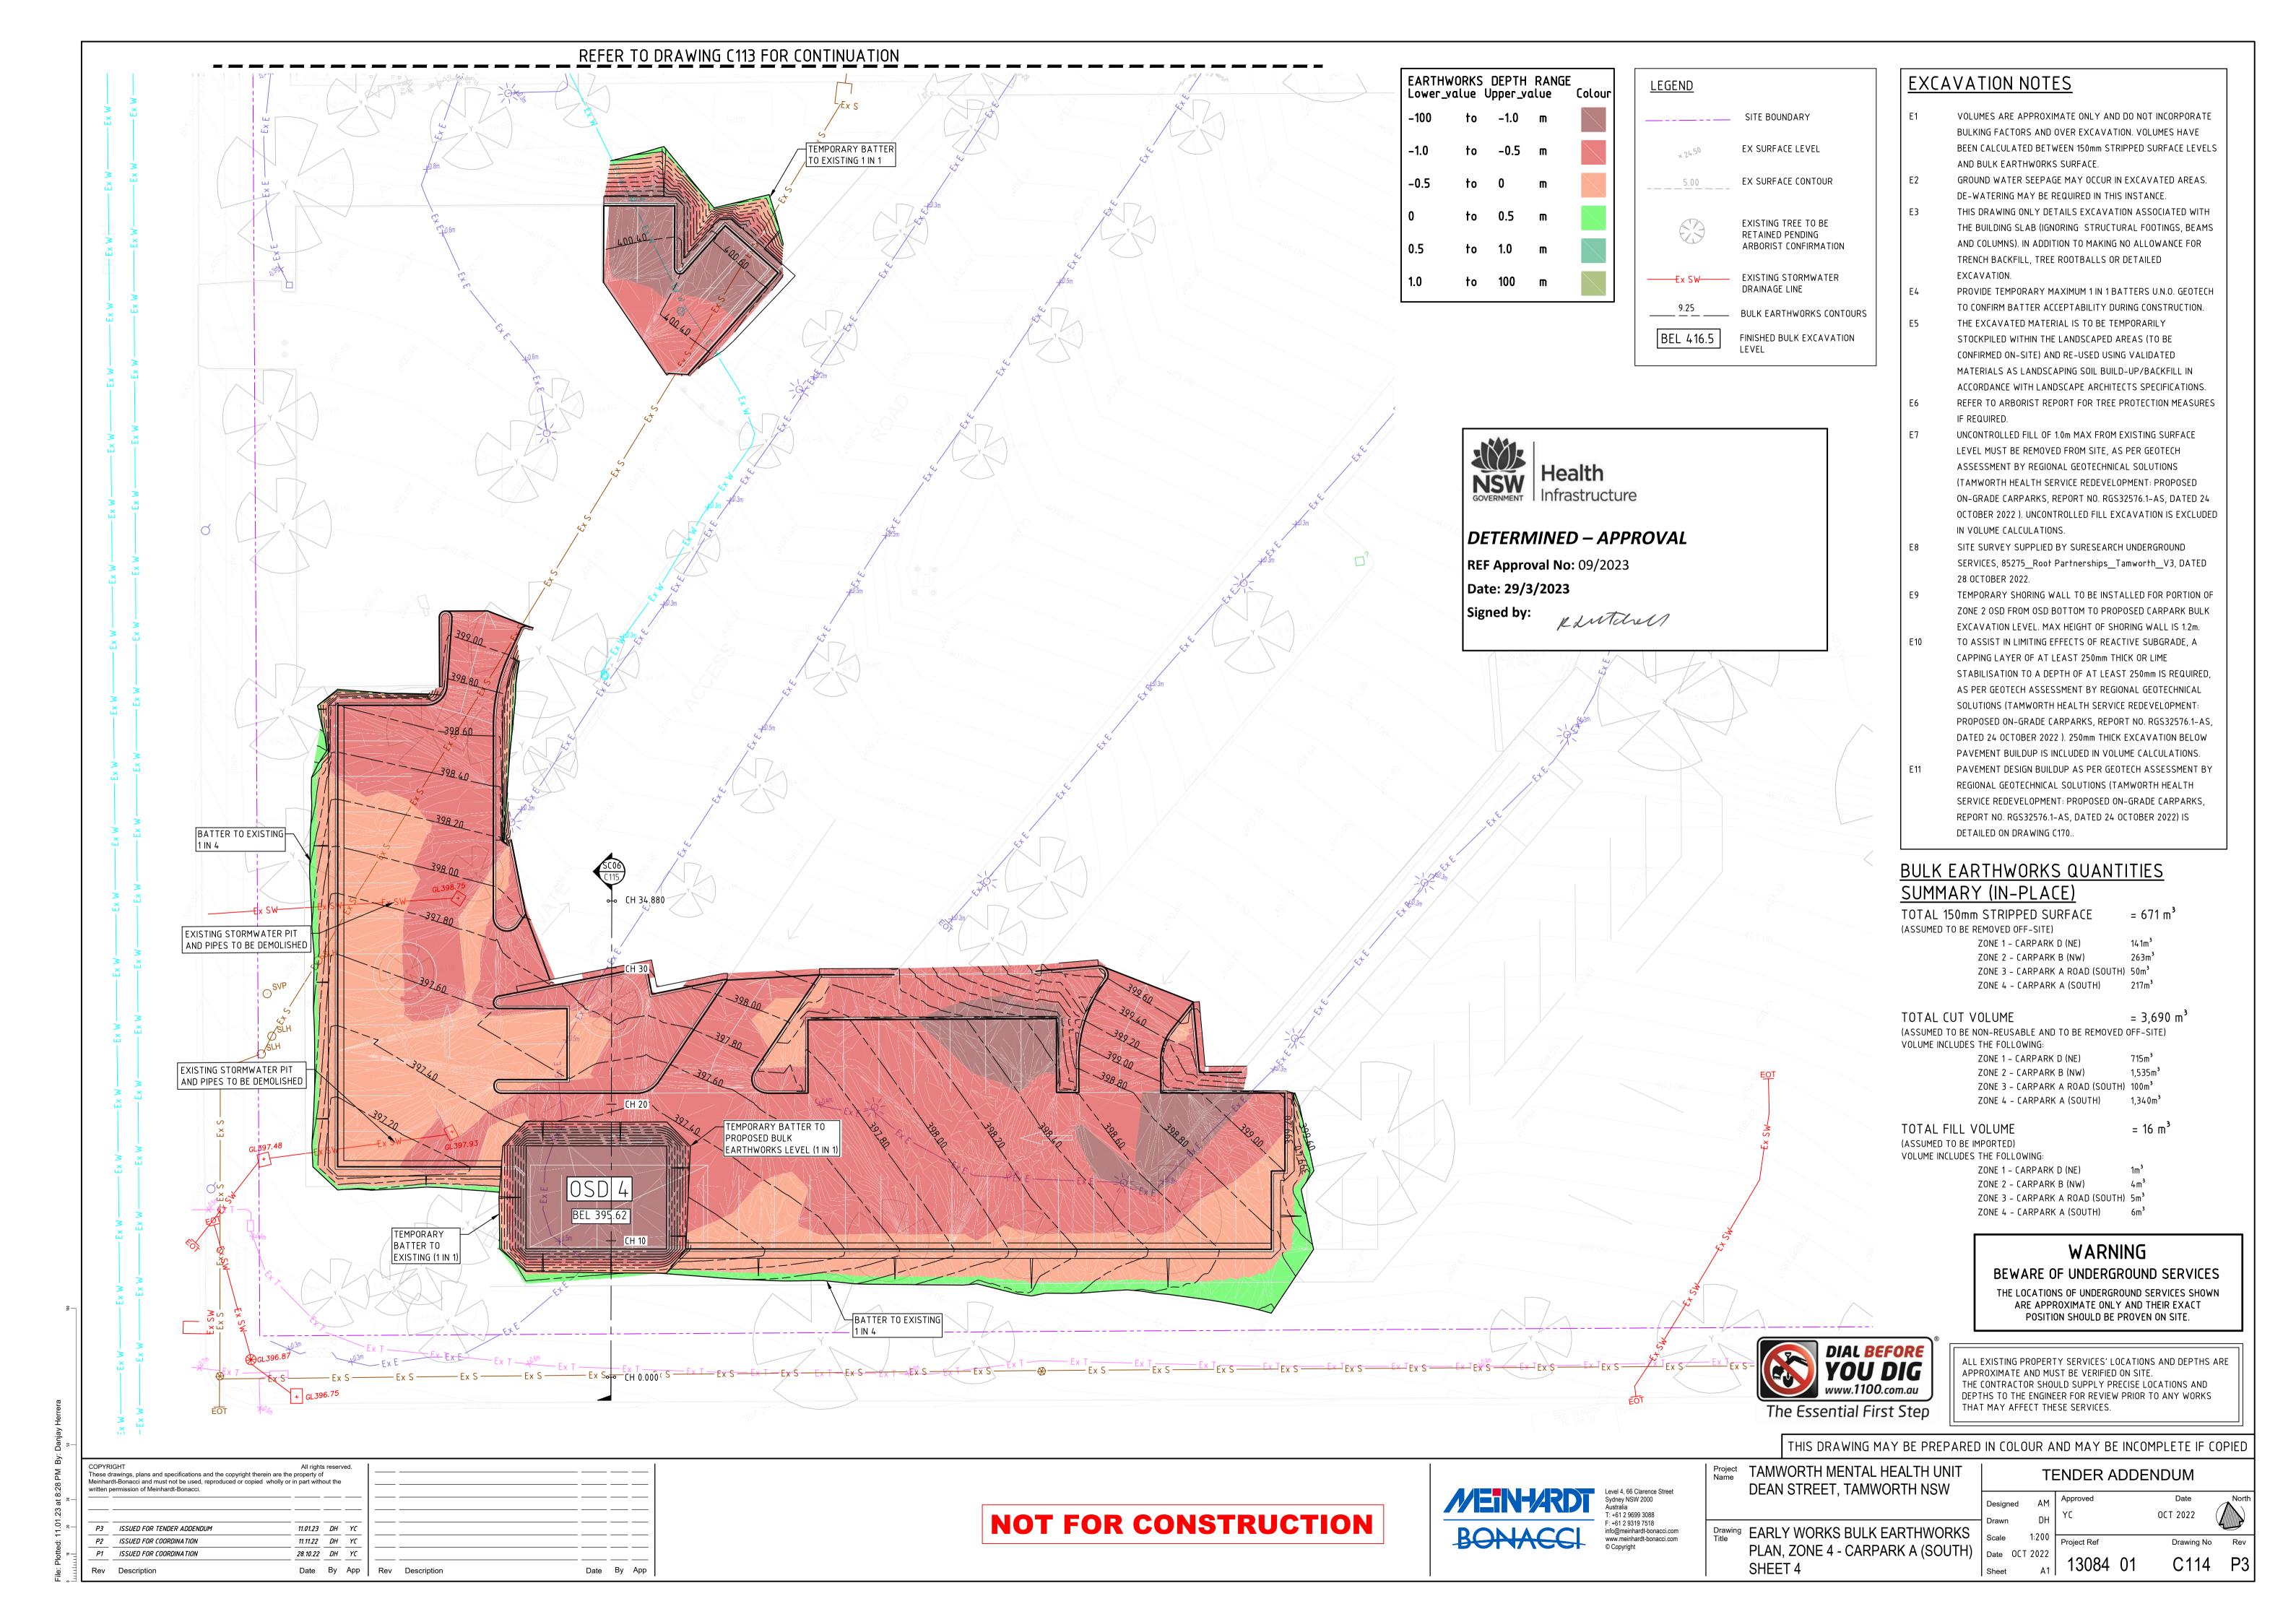
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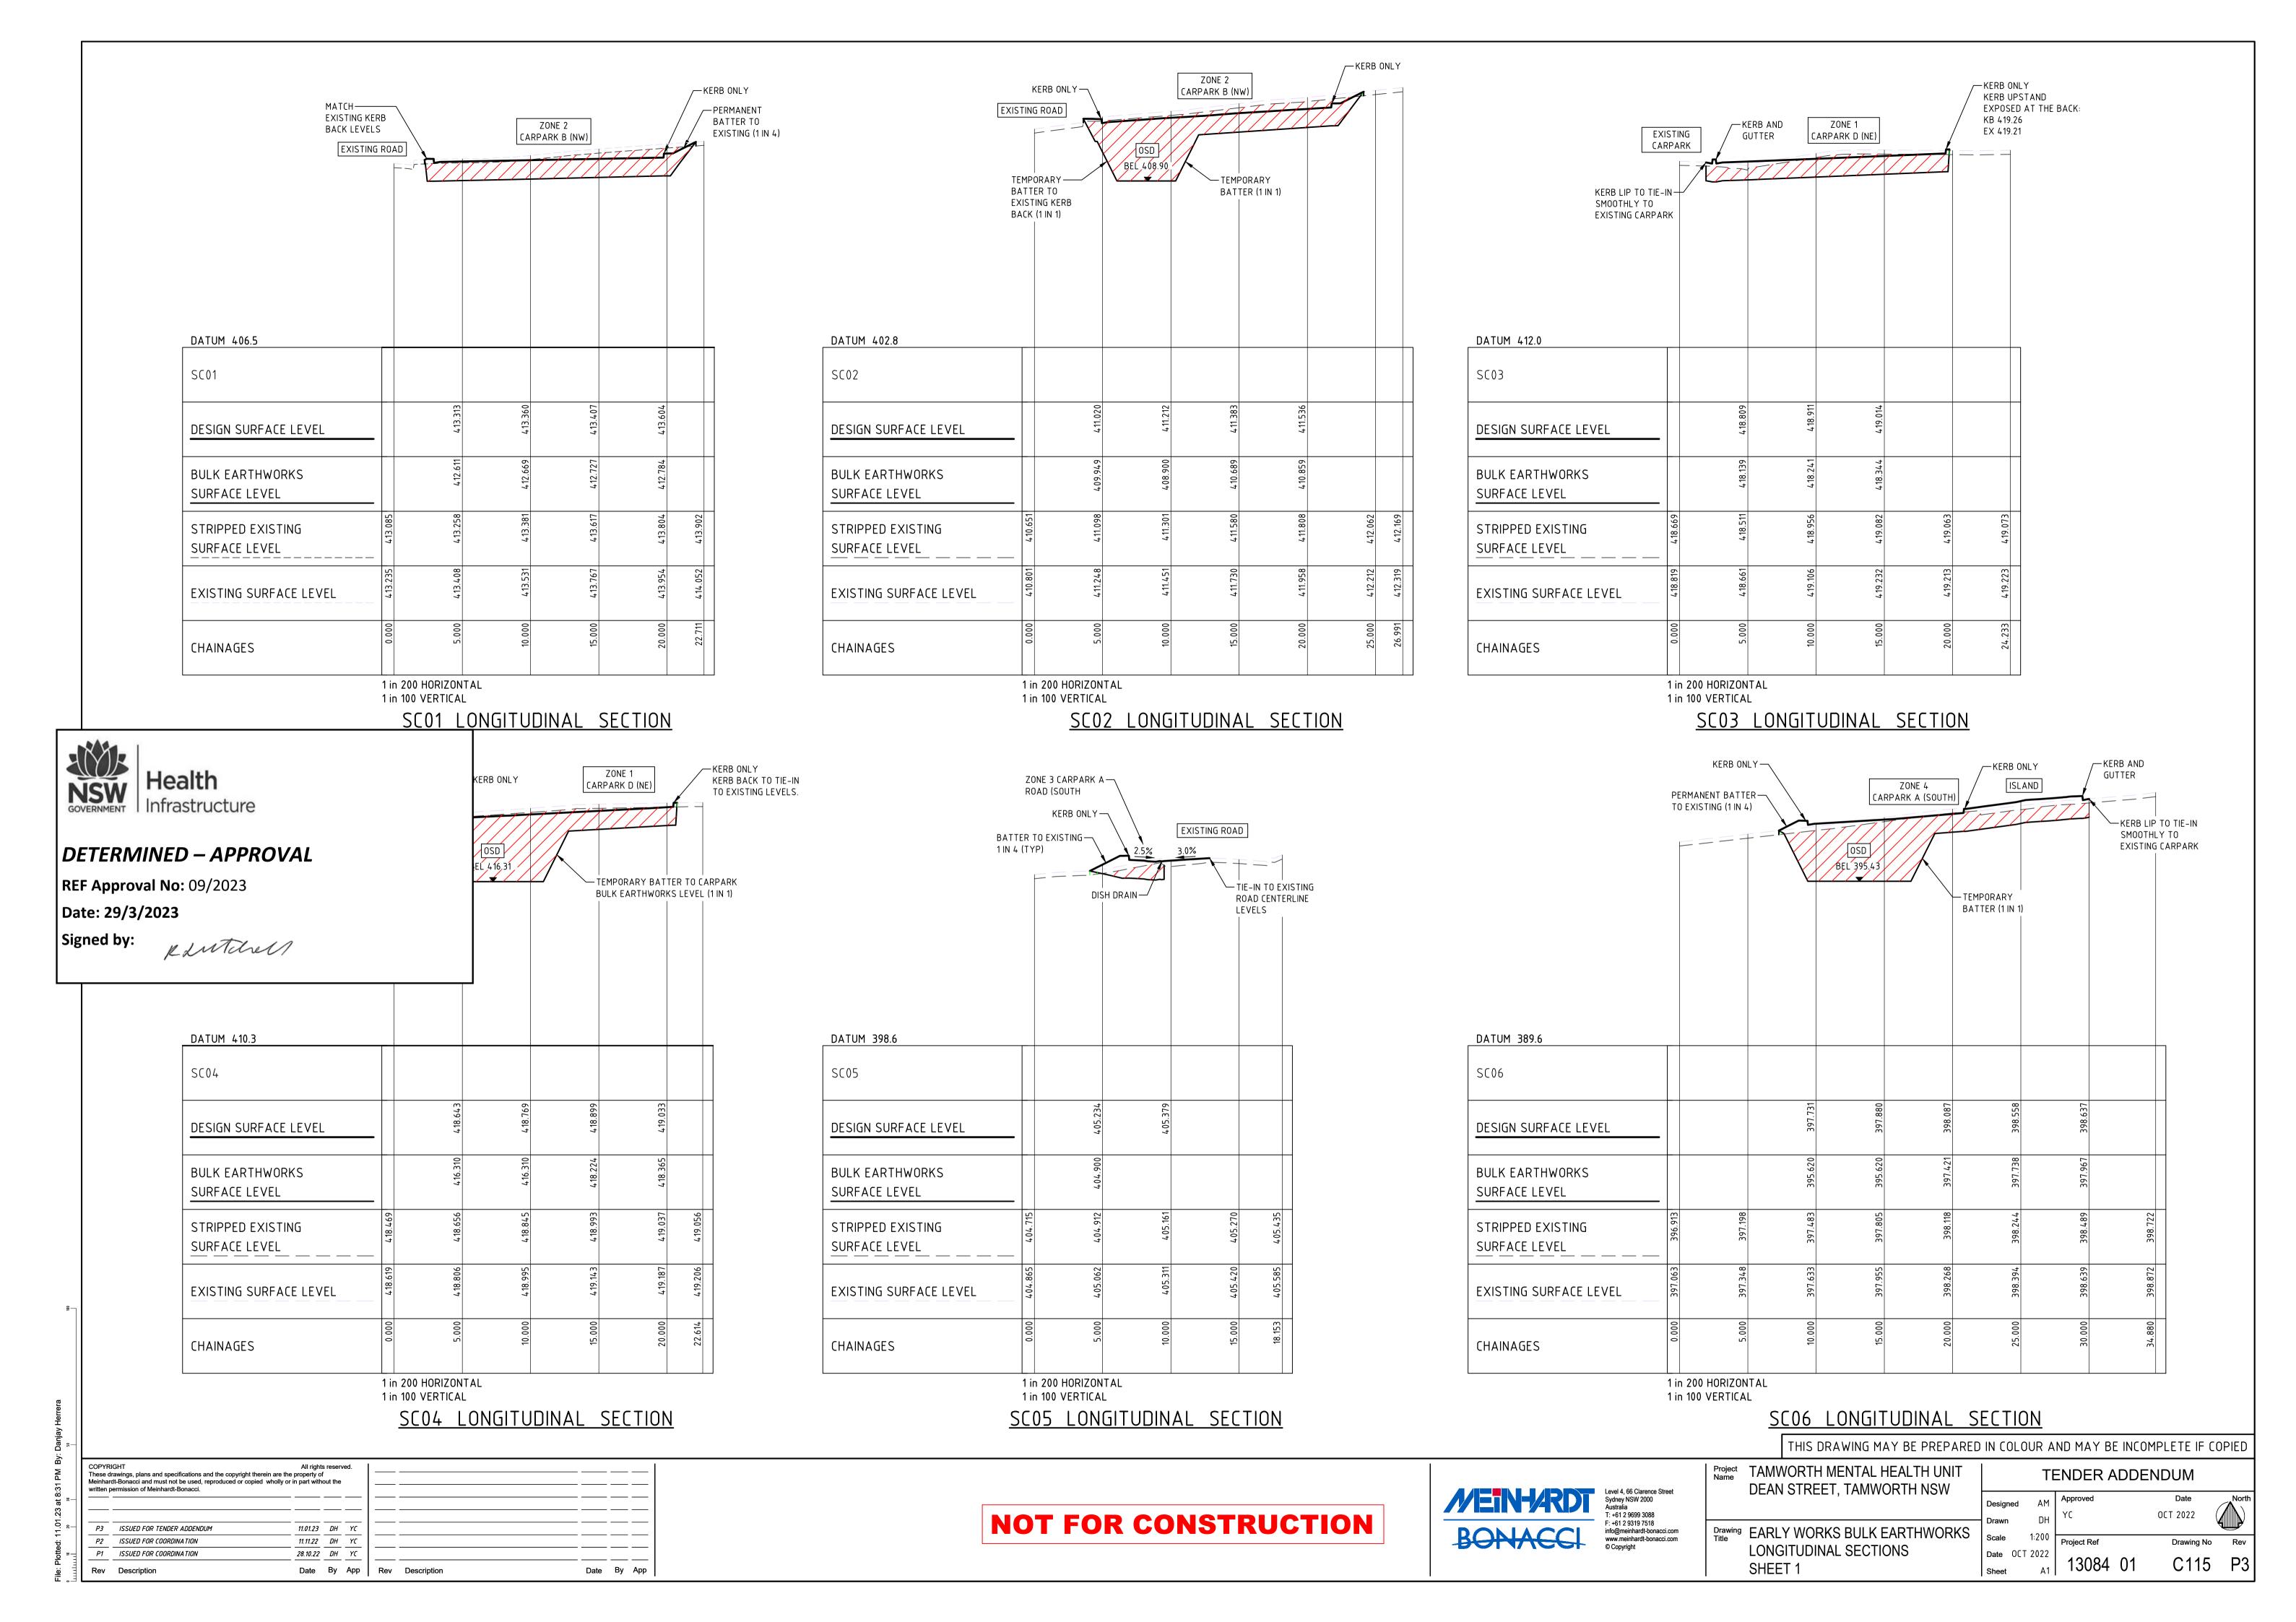
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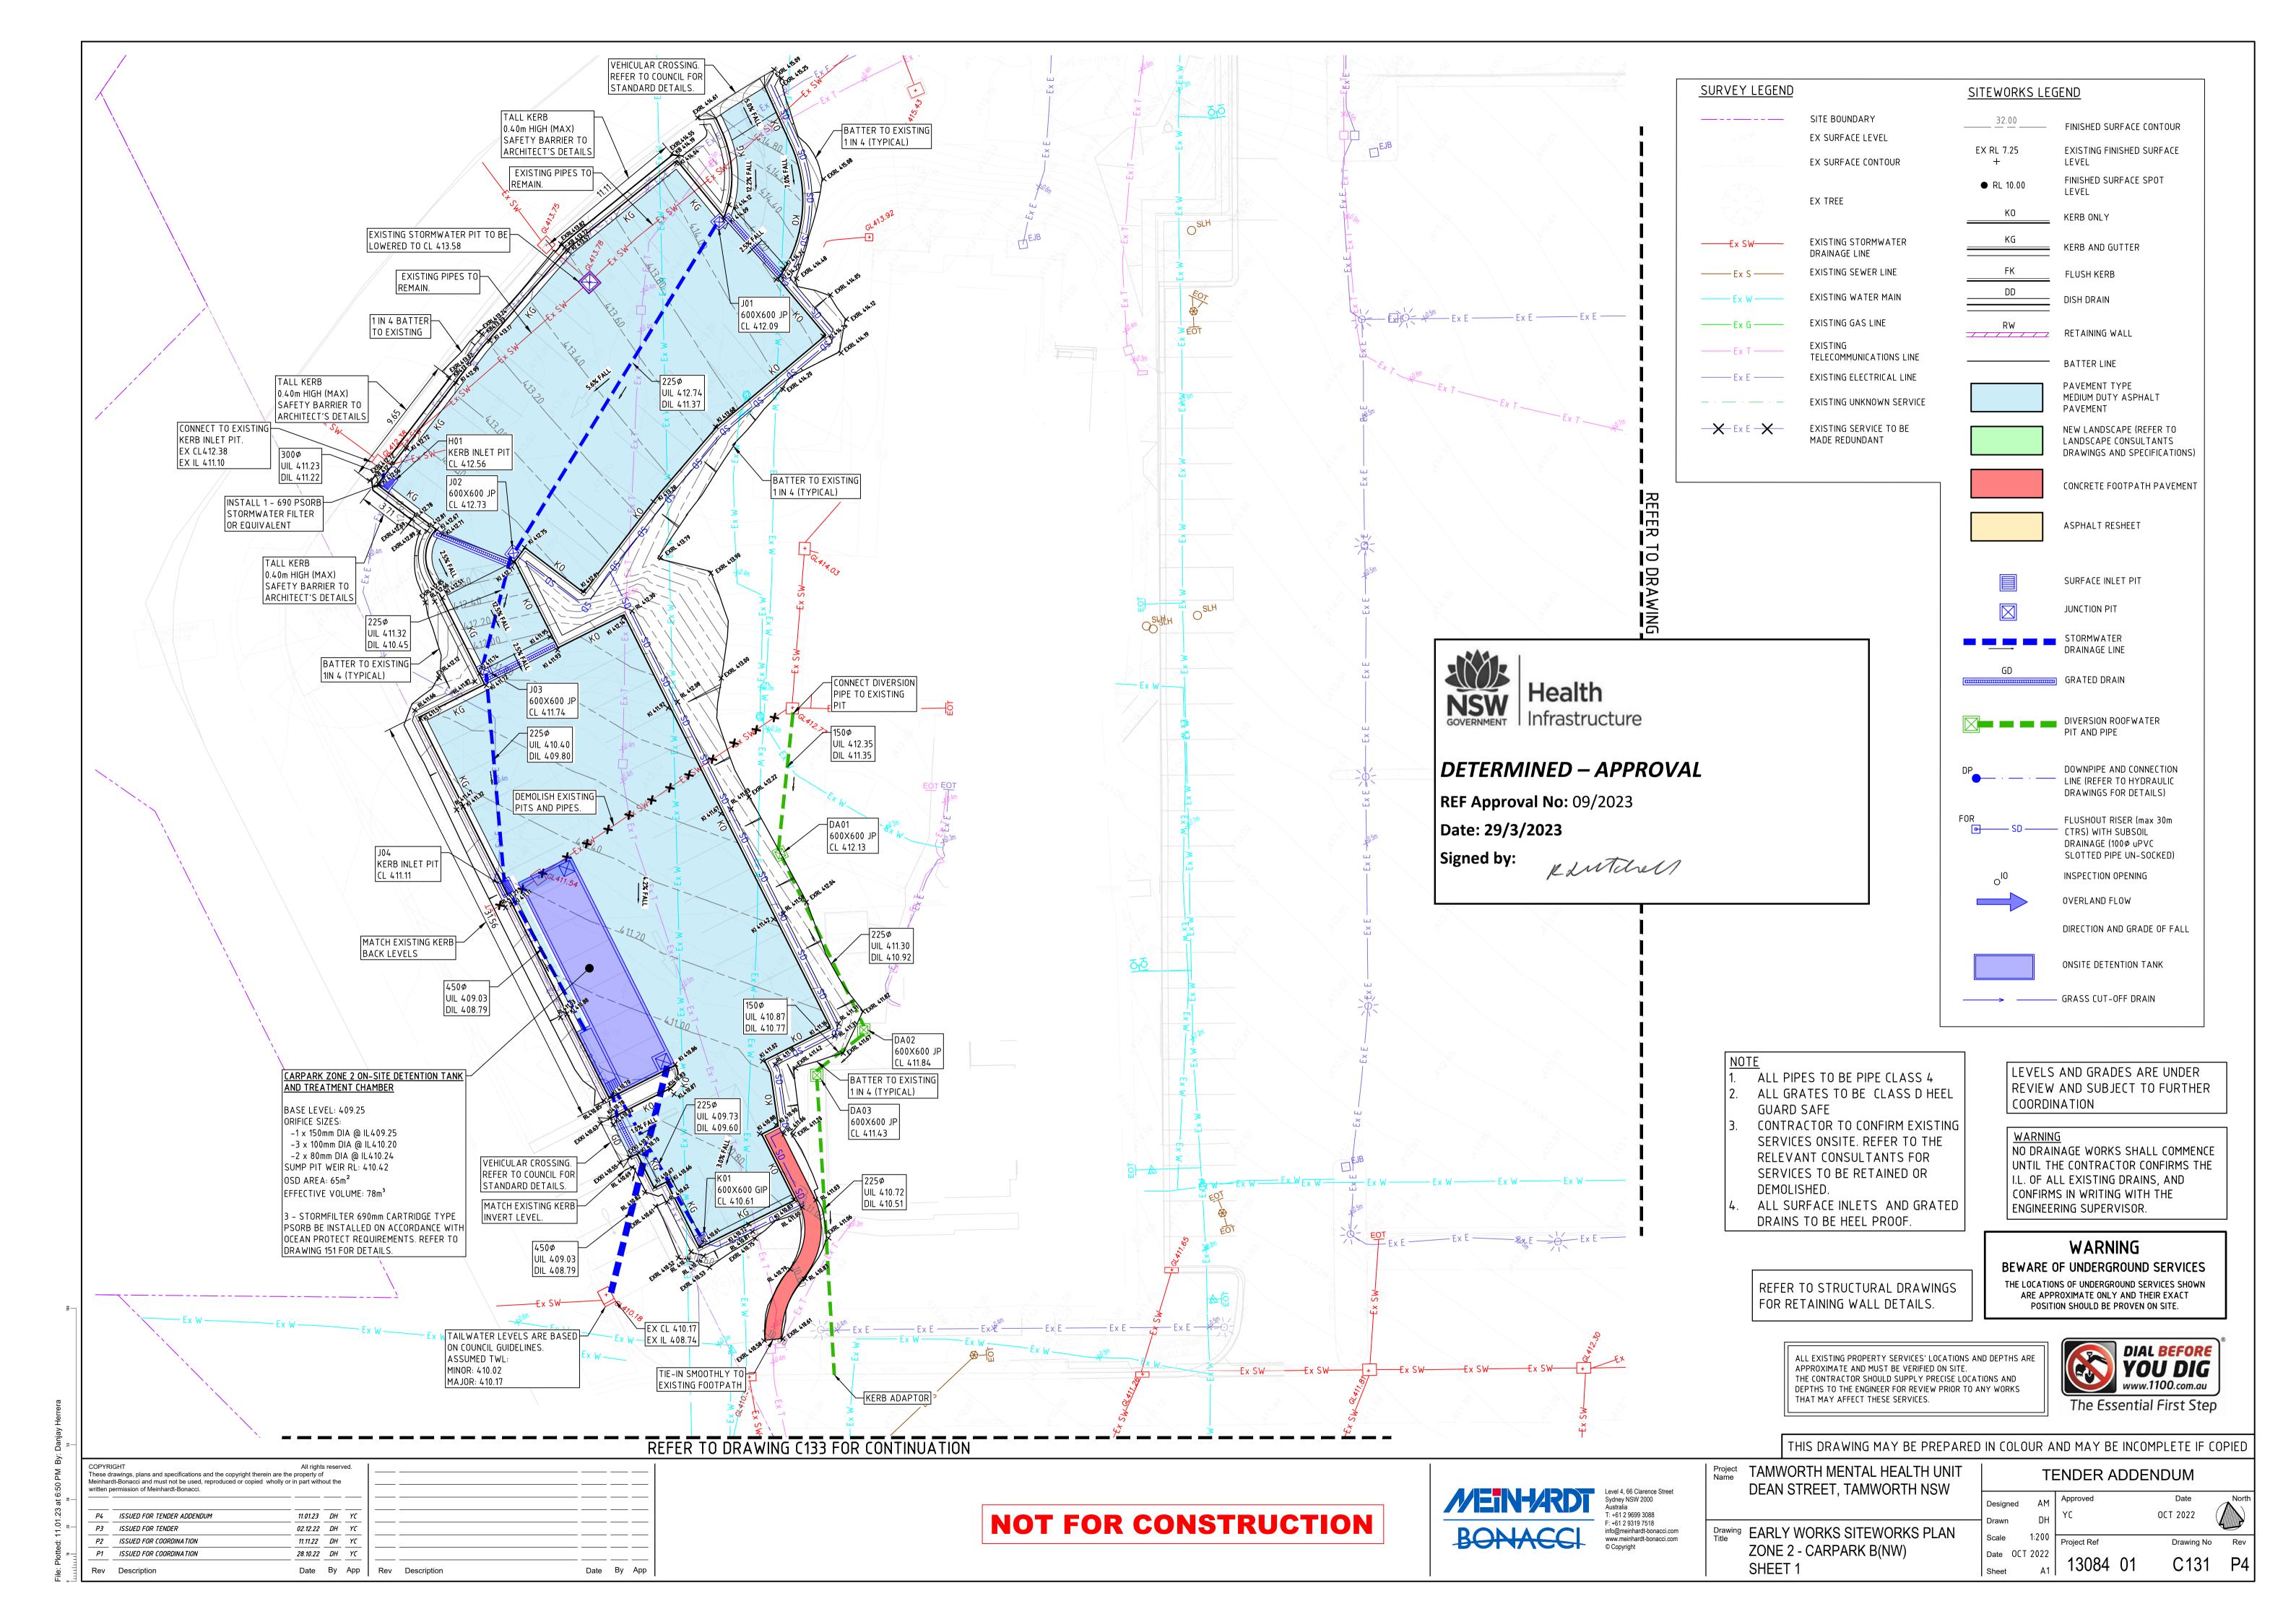
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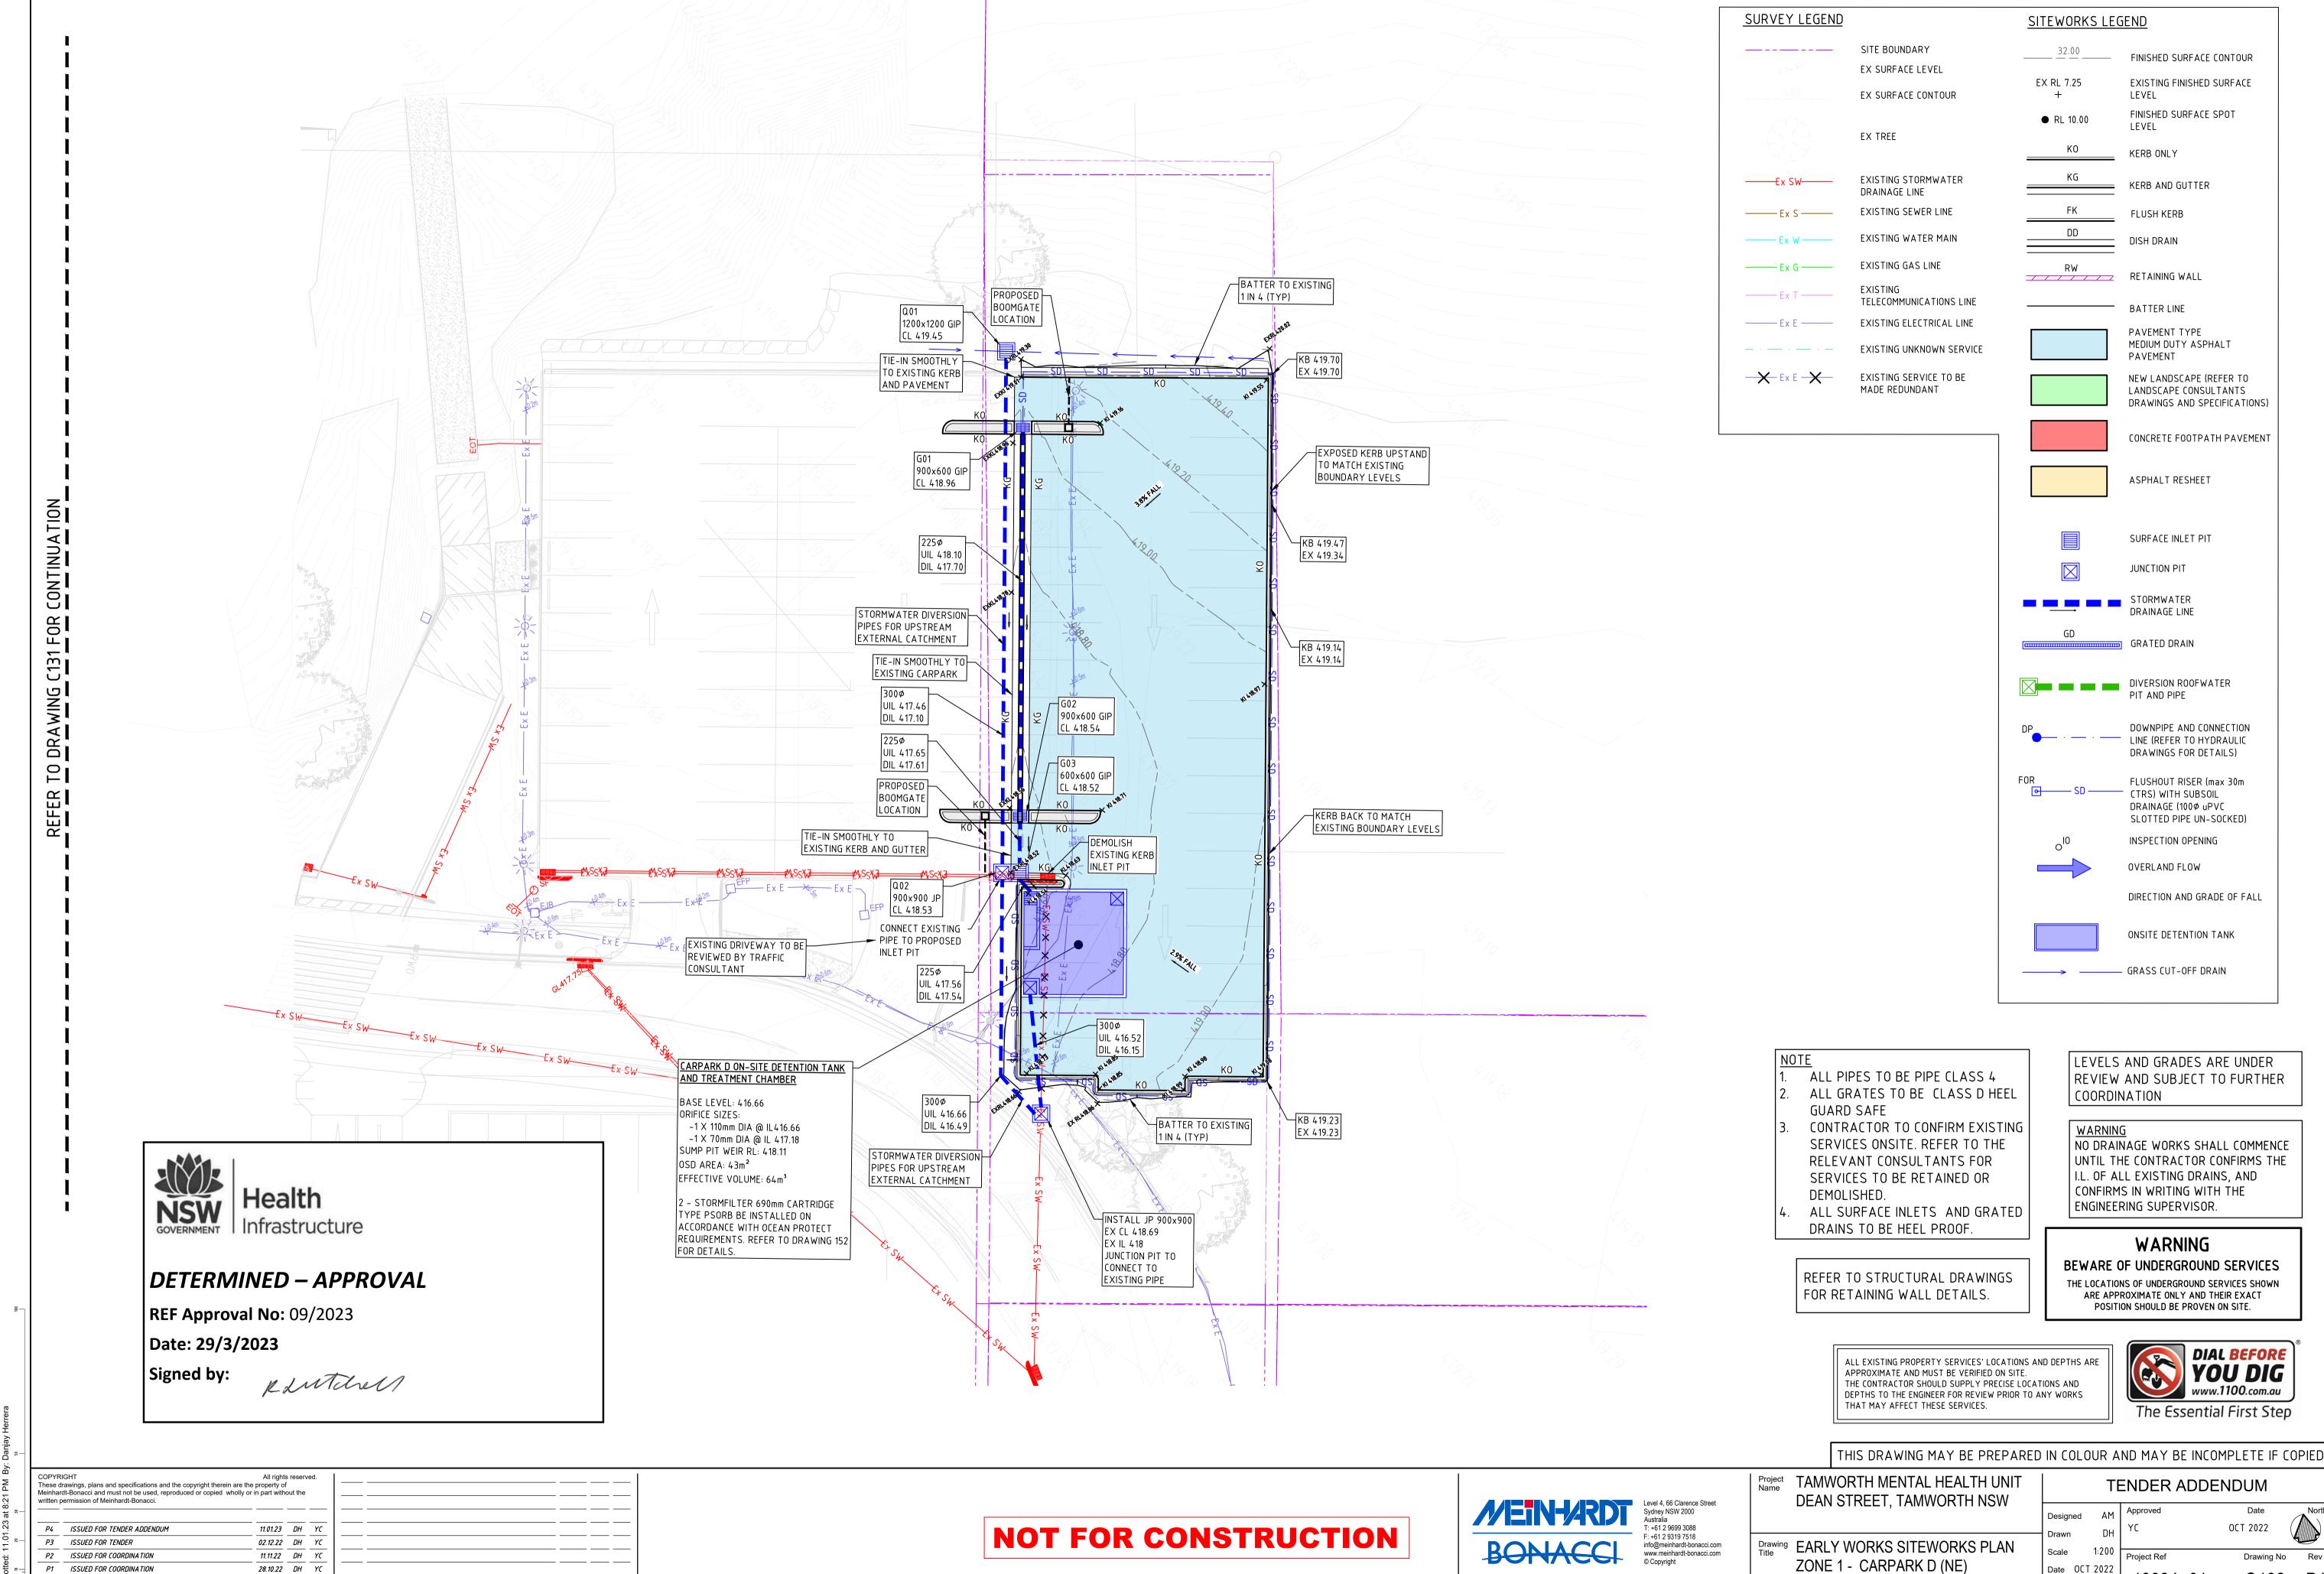
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SHEET 2

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C132 P4


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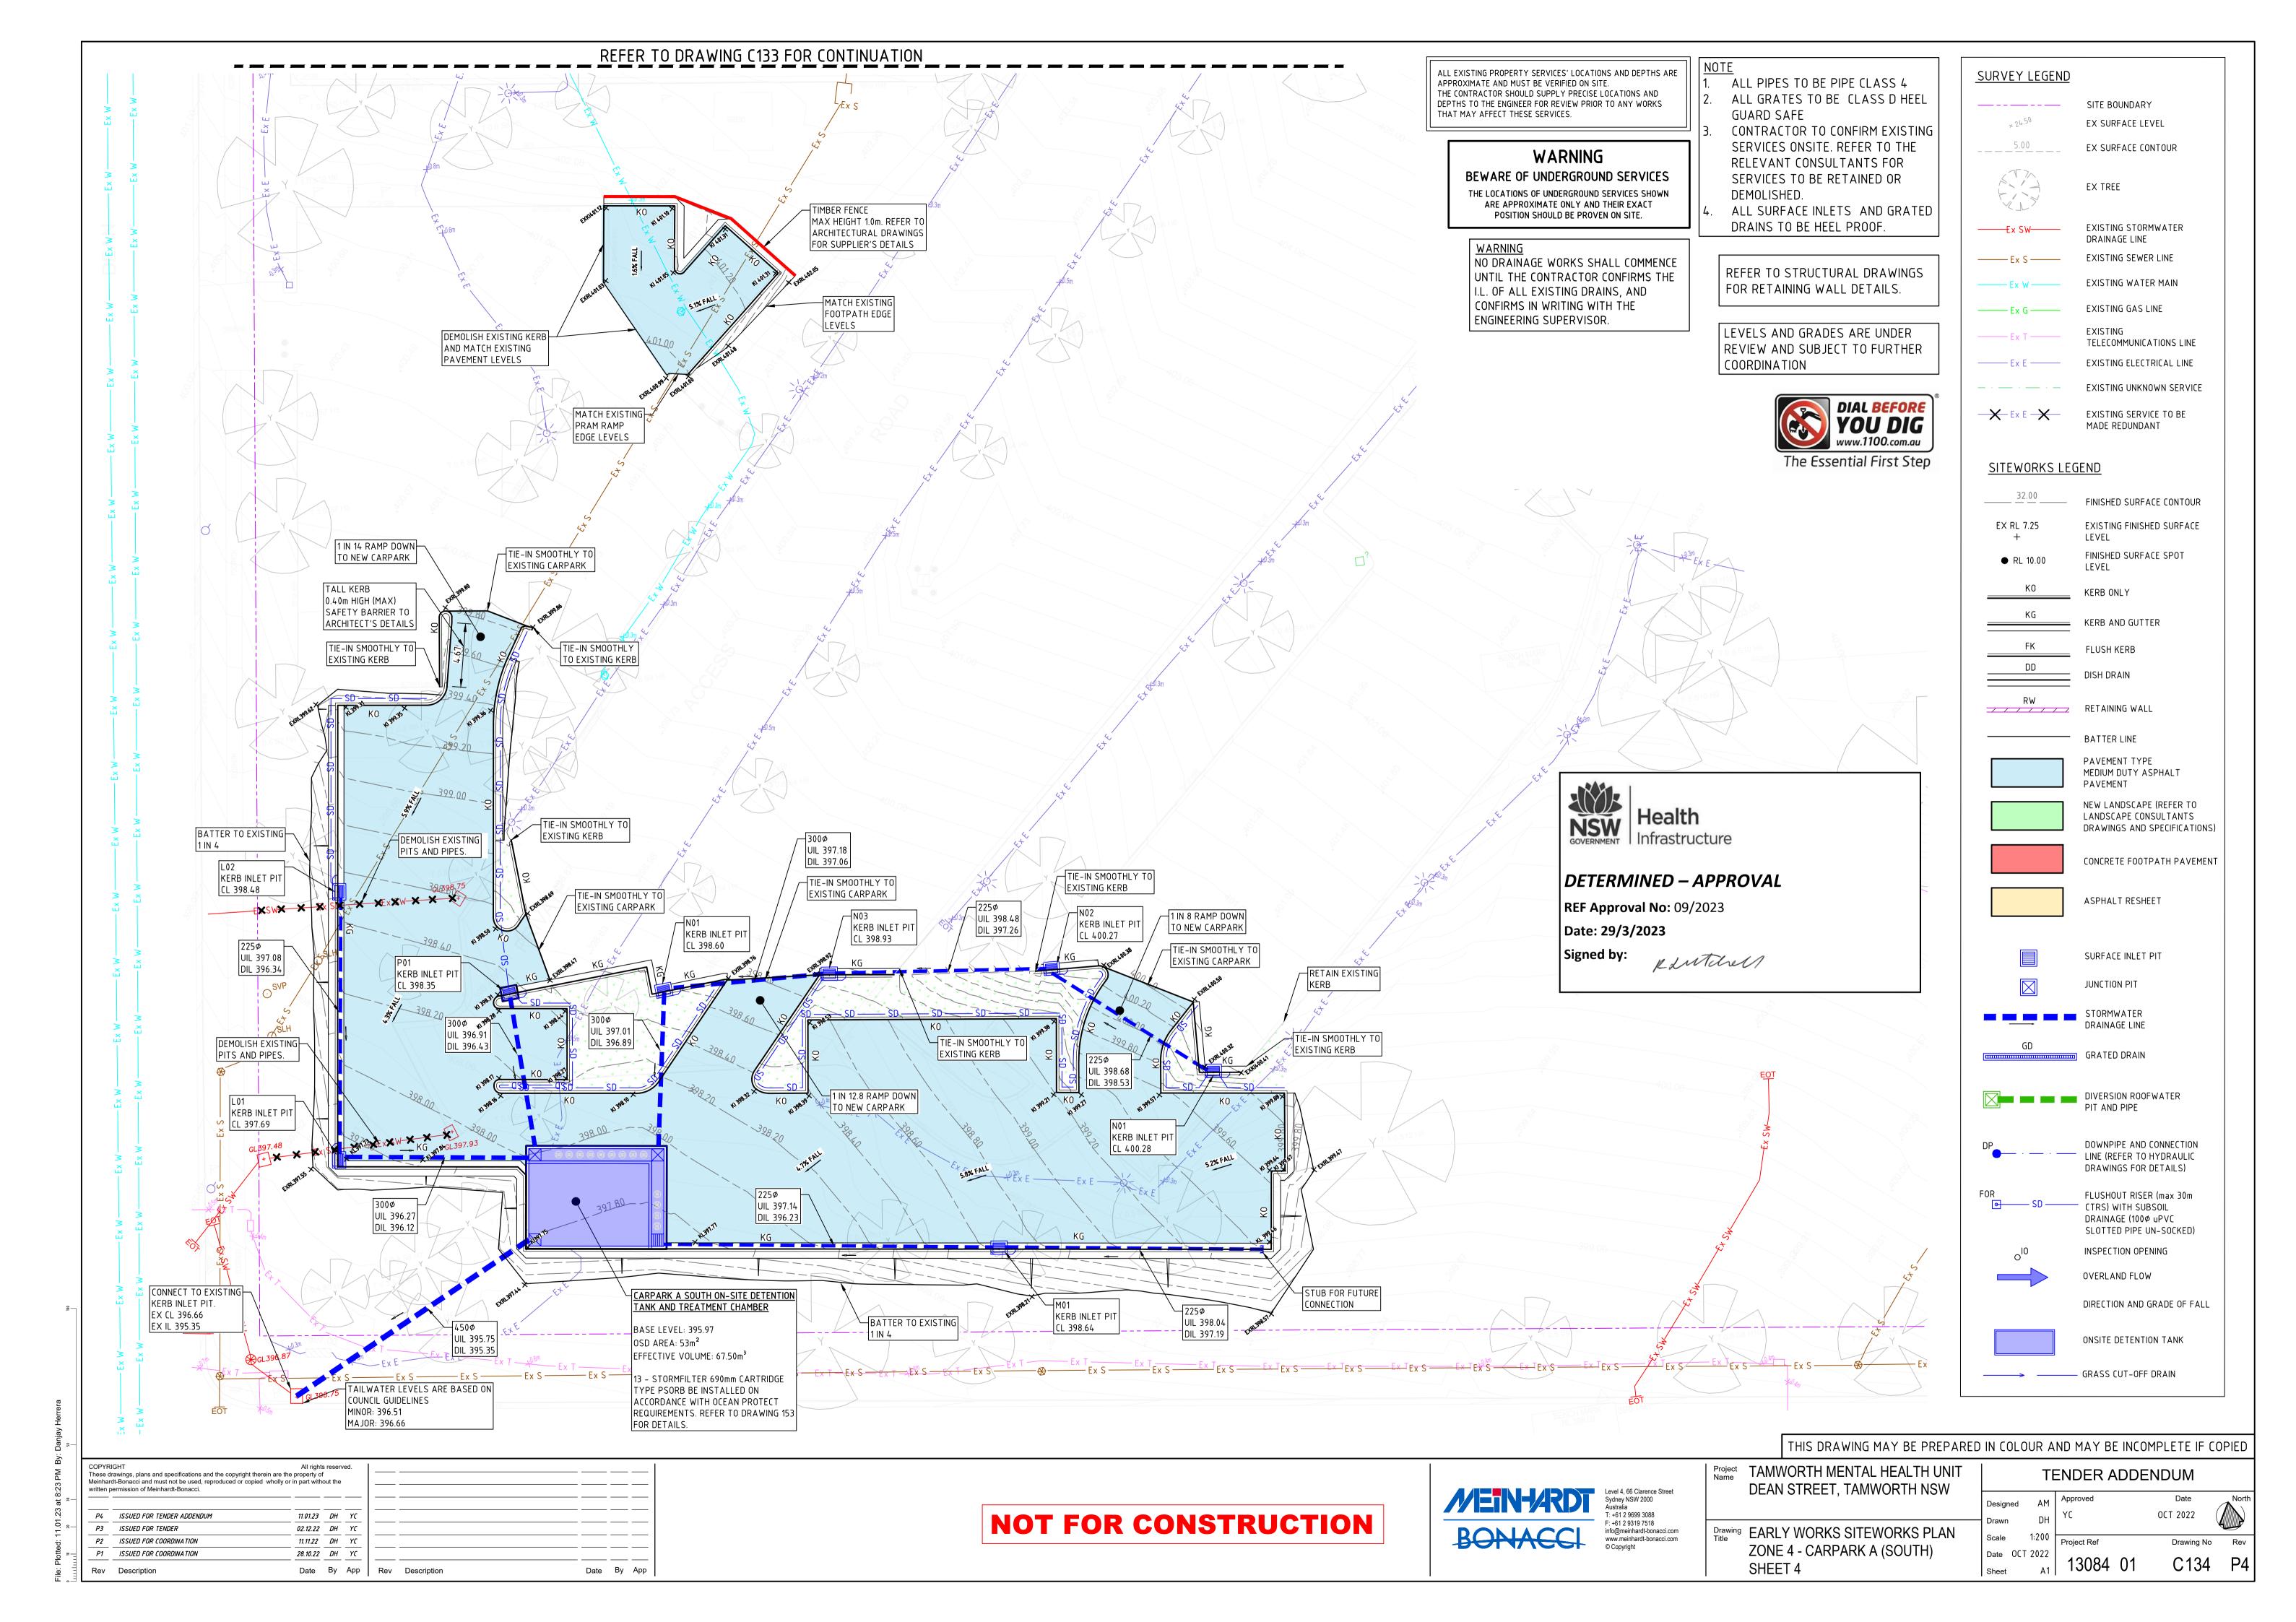
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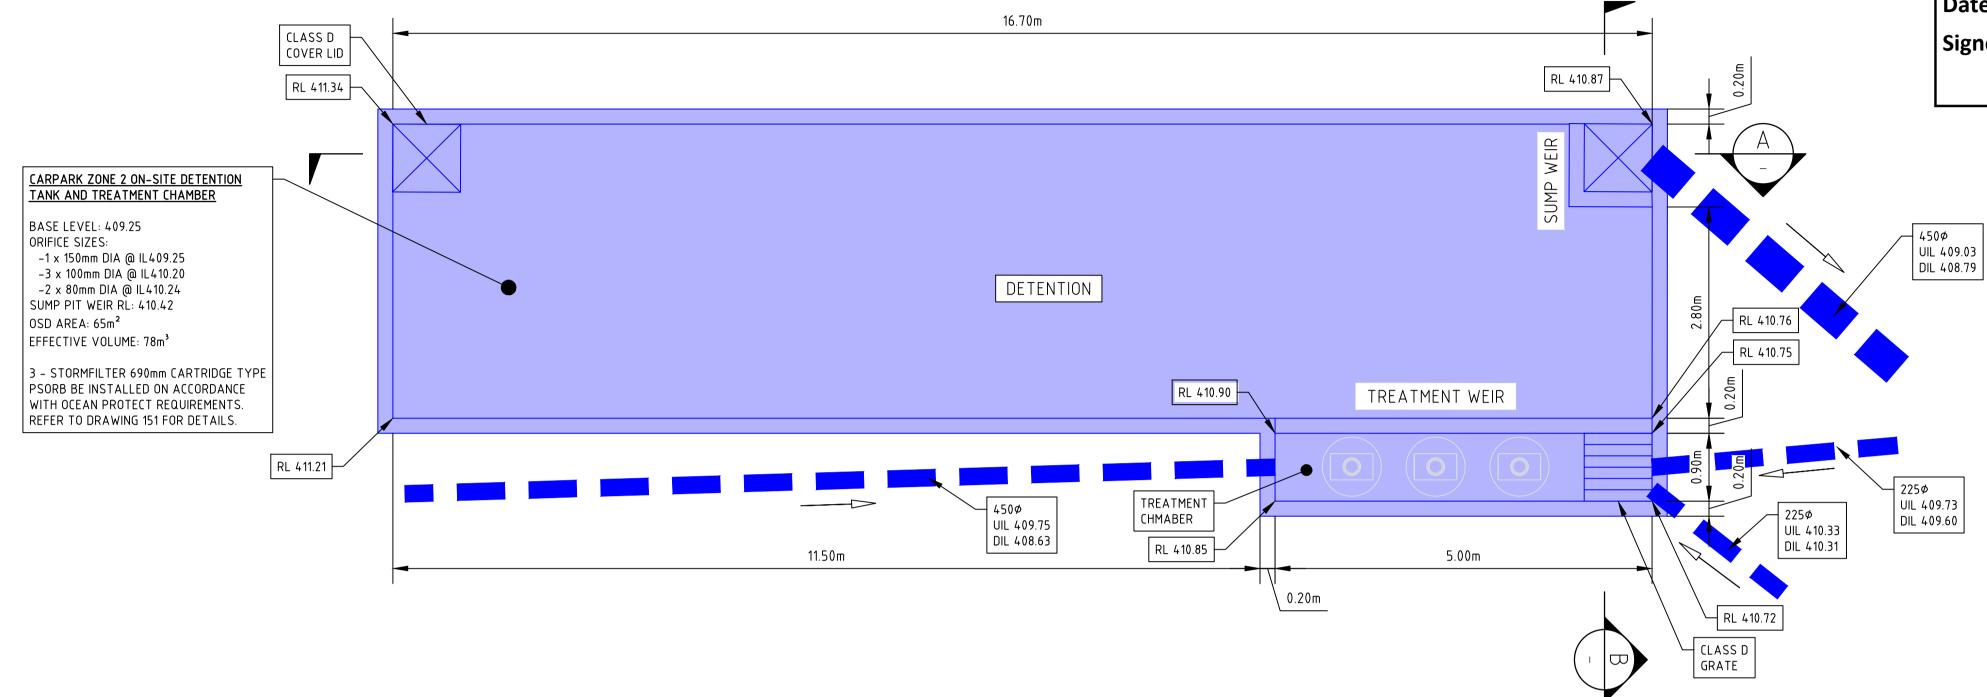
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REF Approval No: 09/2023


Date: 29/3/2023

Signed by:

R Lutchell

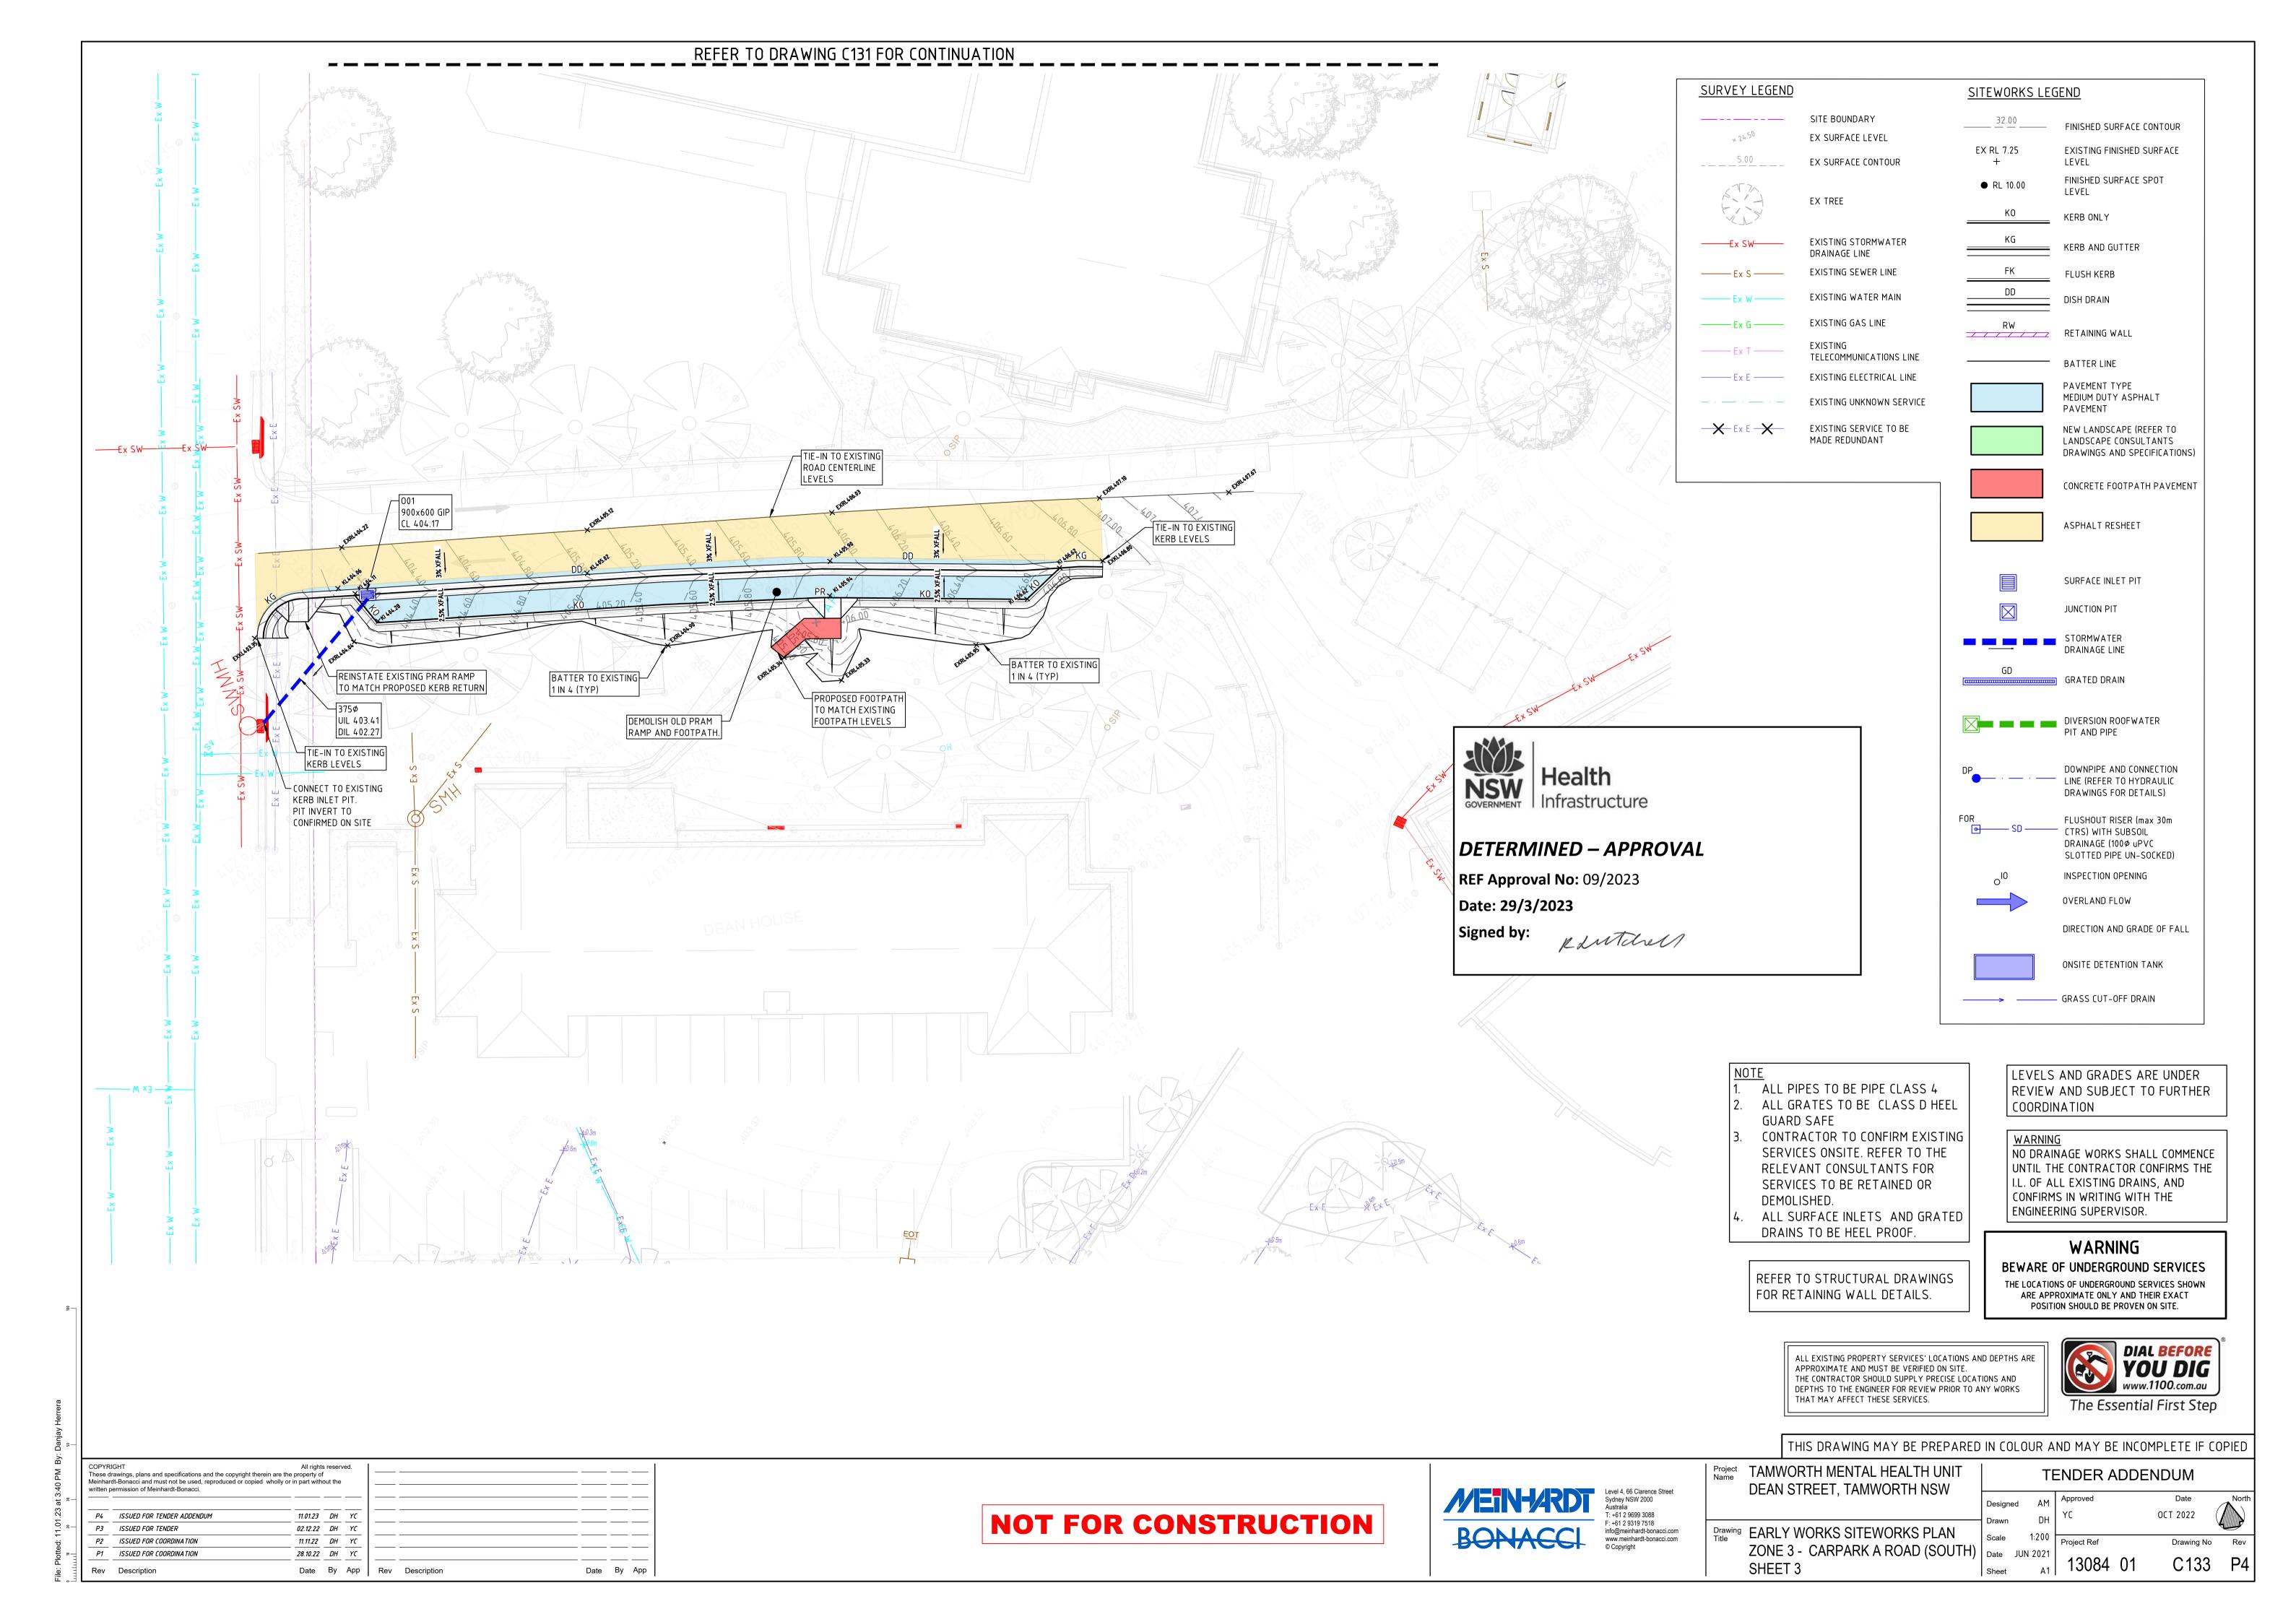

NORTH WEST CARPARK ZONE 2 ON SITE DETENTION PLAN SCALE 1:50

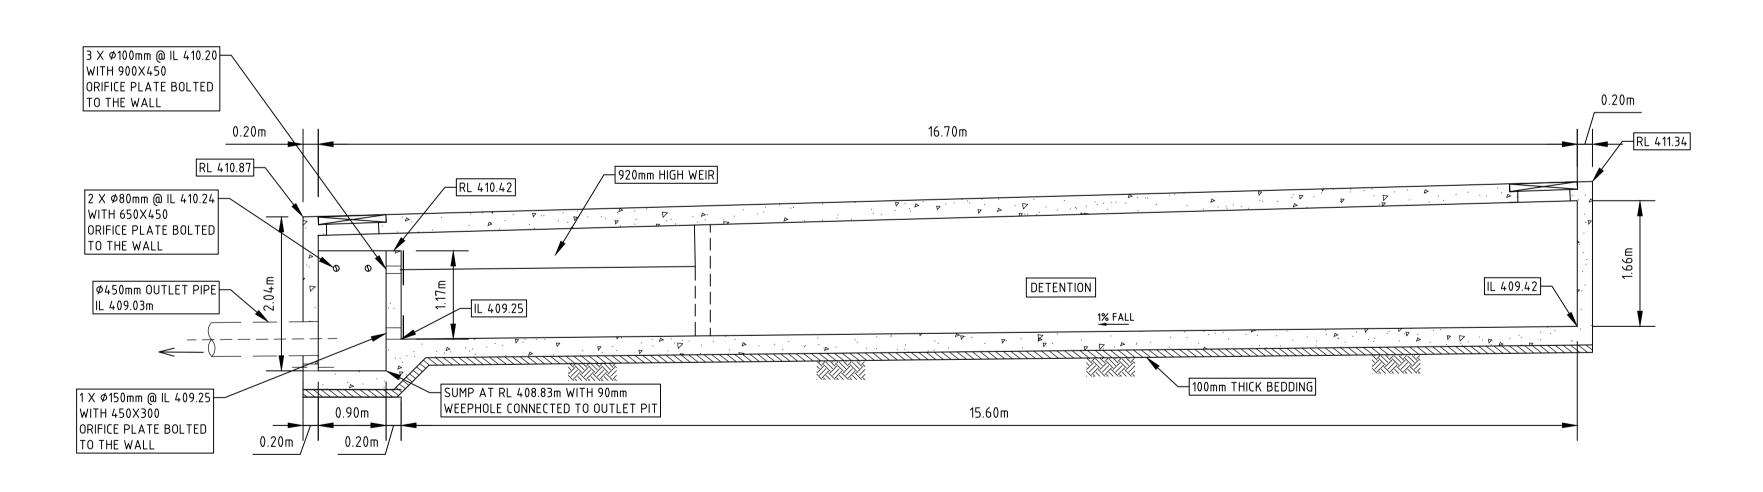

5.00m 920mm HIGH WEIR RL 410.87 -INTERNAL WEIR RL 410.72 RL 410.42 TREATMENT CHAMBER IL 409.25 2 X @80mm IL 410.24 WITH 650X450 ORIFICE PLATE BOLTED TO THE WALL 100mm FALSE SLAB 1.30m 0.90 mTREATMENT OUTLET PIPE Ø450mm OUTLET PIPE-IL 409.03 100mm THICK 0.20m / 0.20m / BEDDING SUMP AT RL 408.83m WITH 90mm WEEPHOLE CONNECTED TO OUTLET PIT SECTION B-B SCALE 1:50

SECTION A-A

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					YC	OCT 2022	

Drawing Title EARLY WORKS

ZONE 2 - CARPARK B (NW)


ON-SITE DETENTION TANK DETAILS


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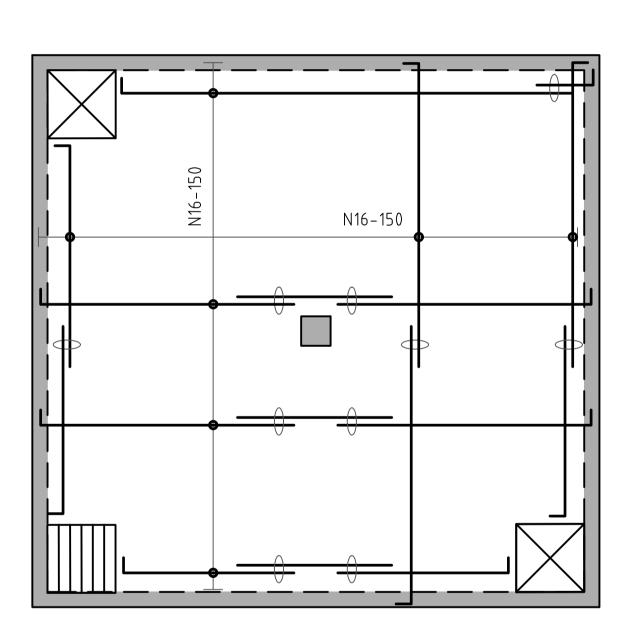





- REFER TO ADJACENT DETAIL FOR DETAILS OF MINIMUM STRUCTURAL DEPTH REQUIREMENTS

OSD TANK BASE SLAB PLAN SCALE 1:50

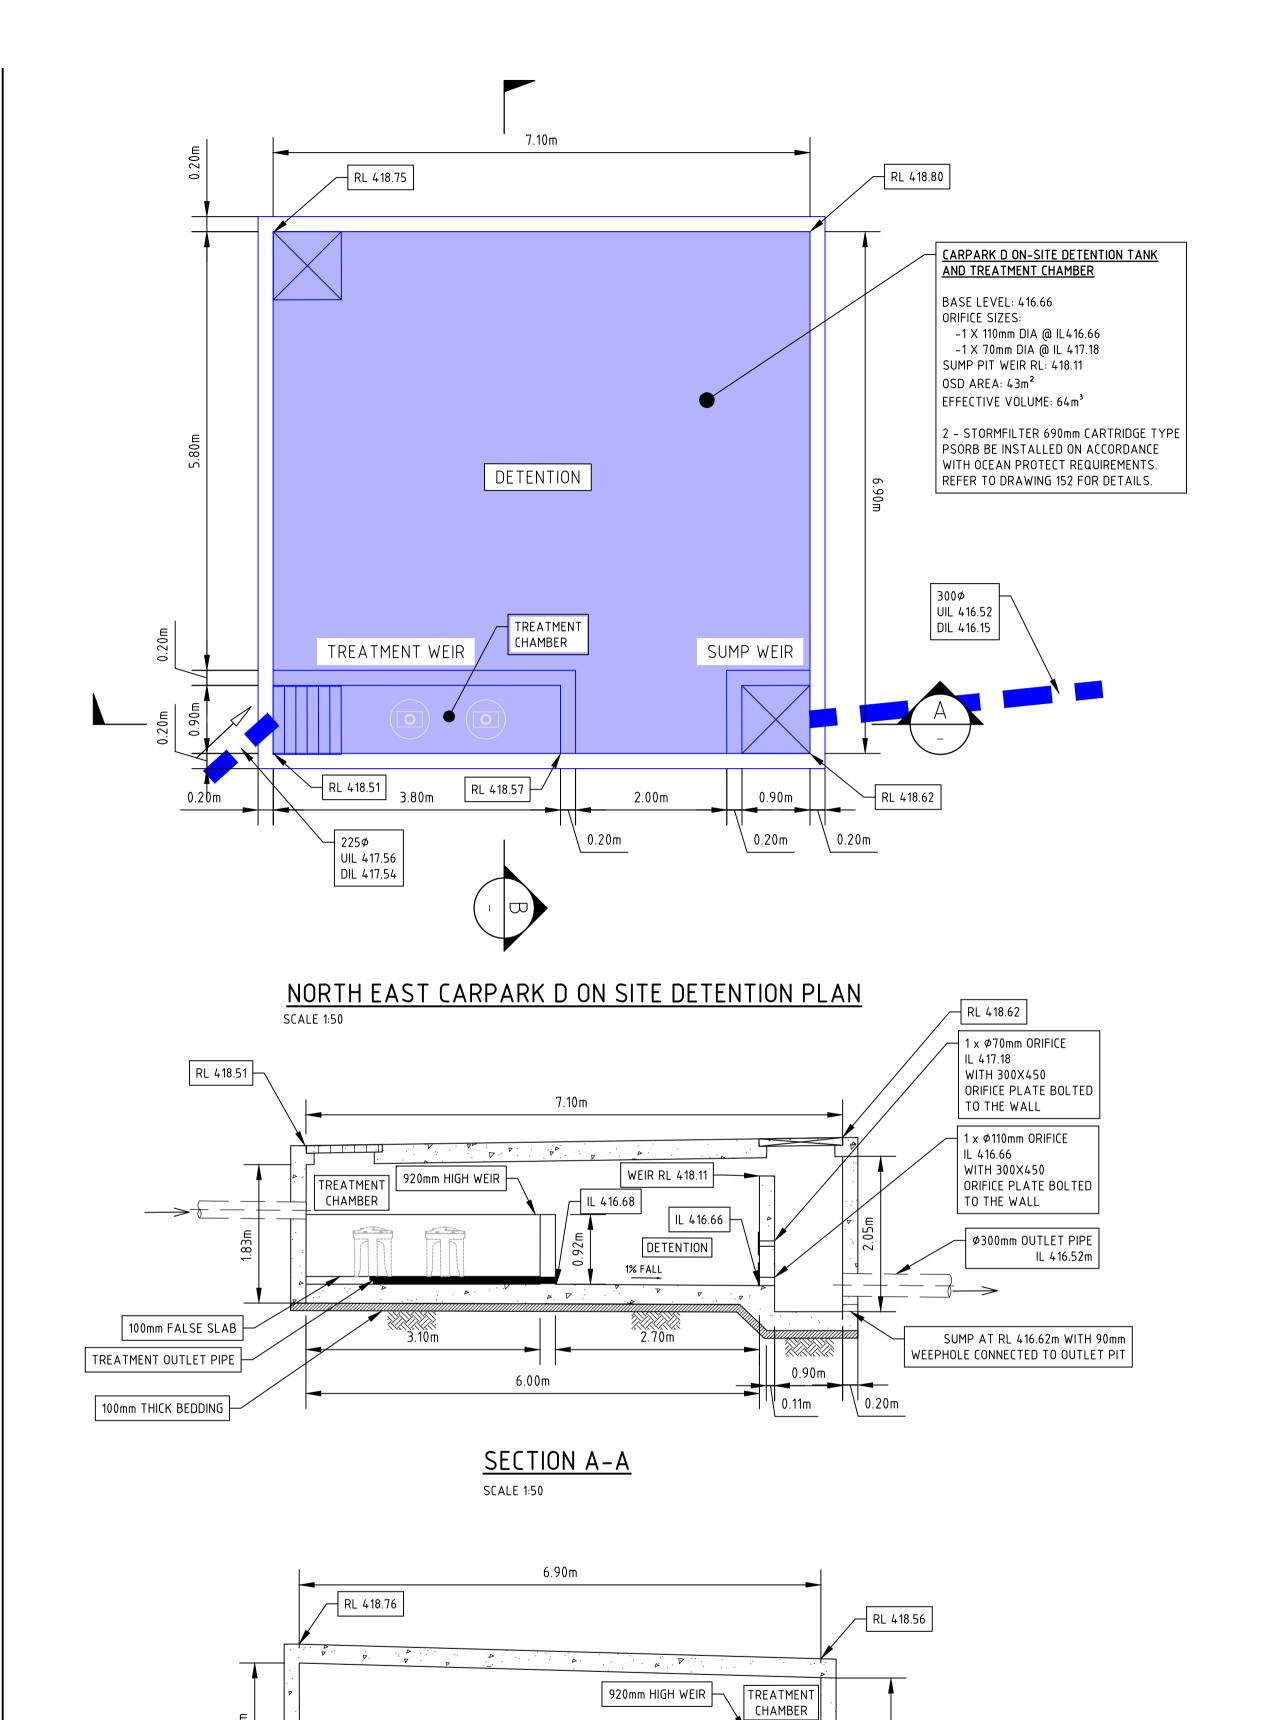OSD TANK LID SLAB PLAN

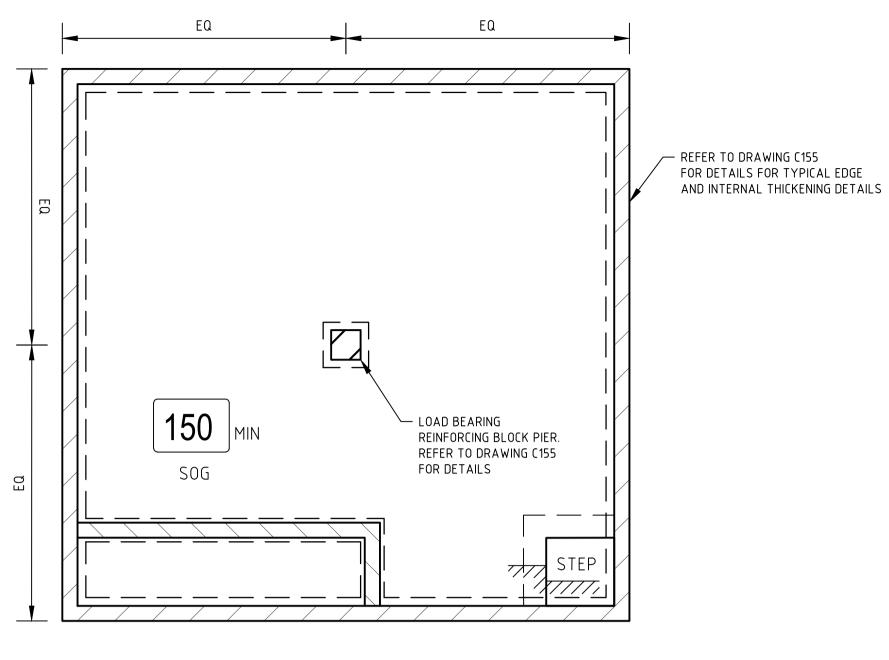

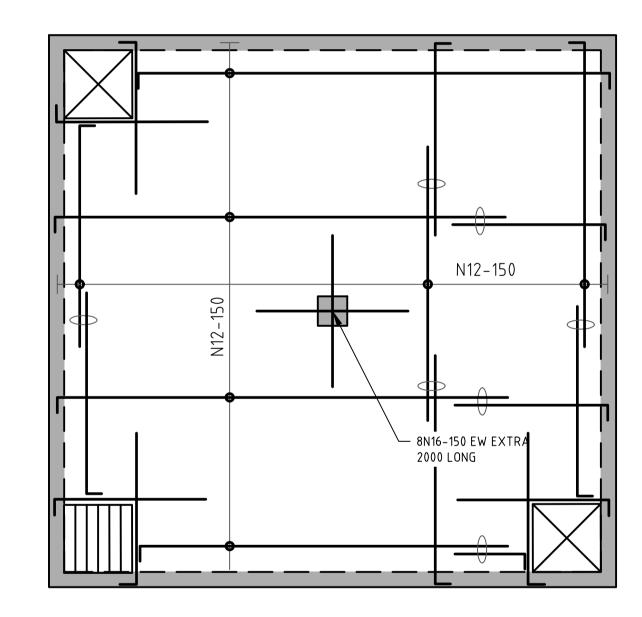

OSD TANK LID BTM REINFORCEMENT PLAN
SCALE 1:50

OSD TANK LID TOP REINFORCEMENT PLAN
SCALE 1:50



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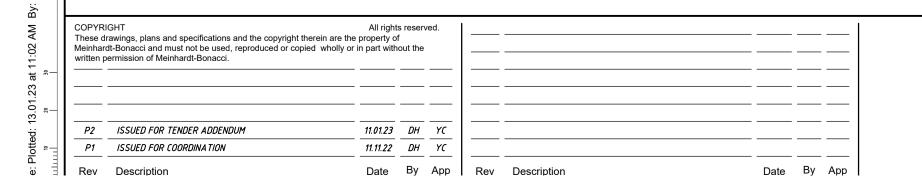
REF Approval No: 09/2023

Date: 29/3/2023

NOTES: USE THE BELOW SPECIFICATIONS: F'c = 40MPaRIO COVER - 20mm

Signed by: RLutchell

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<u></u> IL 416.76

DETENTION

1% FALL

5.80m

SCALE 1:50

100mm THICK BEDDING

SECTION B-B

IL 416.70

0.90m


100mm FALSE SLAB

TREATMENT OUTLET PIPE

NOT FOR CONSTRUCTION



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Project Name	TAMWORTH MENTAL HEALTH UNIT DEAN STREET, TAMWORTH NSW		DENDUM				
	DEAN OTTLET, TAMWORTH NOW	Designed	АМ	Approved	Date	North	
		Drawn	DH	YC	OCT 2022 (
Drawing Title	EARLY WORKS	Scale	NTS				
Title	ZONE 1 - CARPARK D (NE)		T 2022	Project Ref	Drawing No	Rev	
		Date 00		13084 01	C152	P2	
I	ON-SITE DETENTION TANK DETAILS	Sheet	A1	1000 1 01	0 102	1 4	

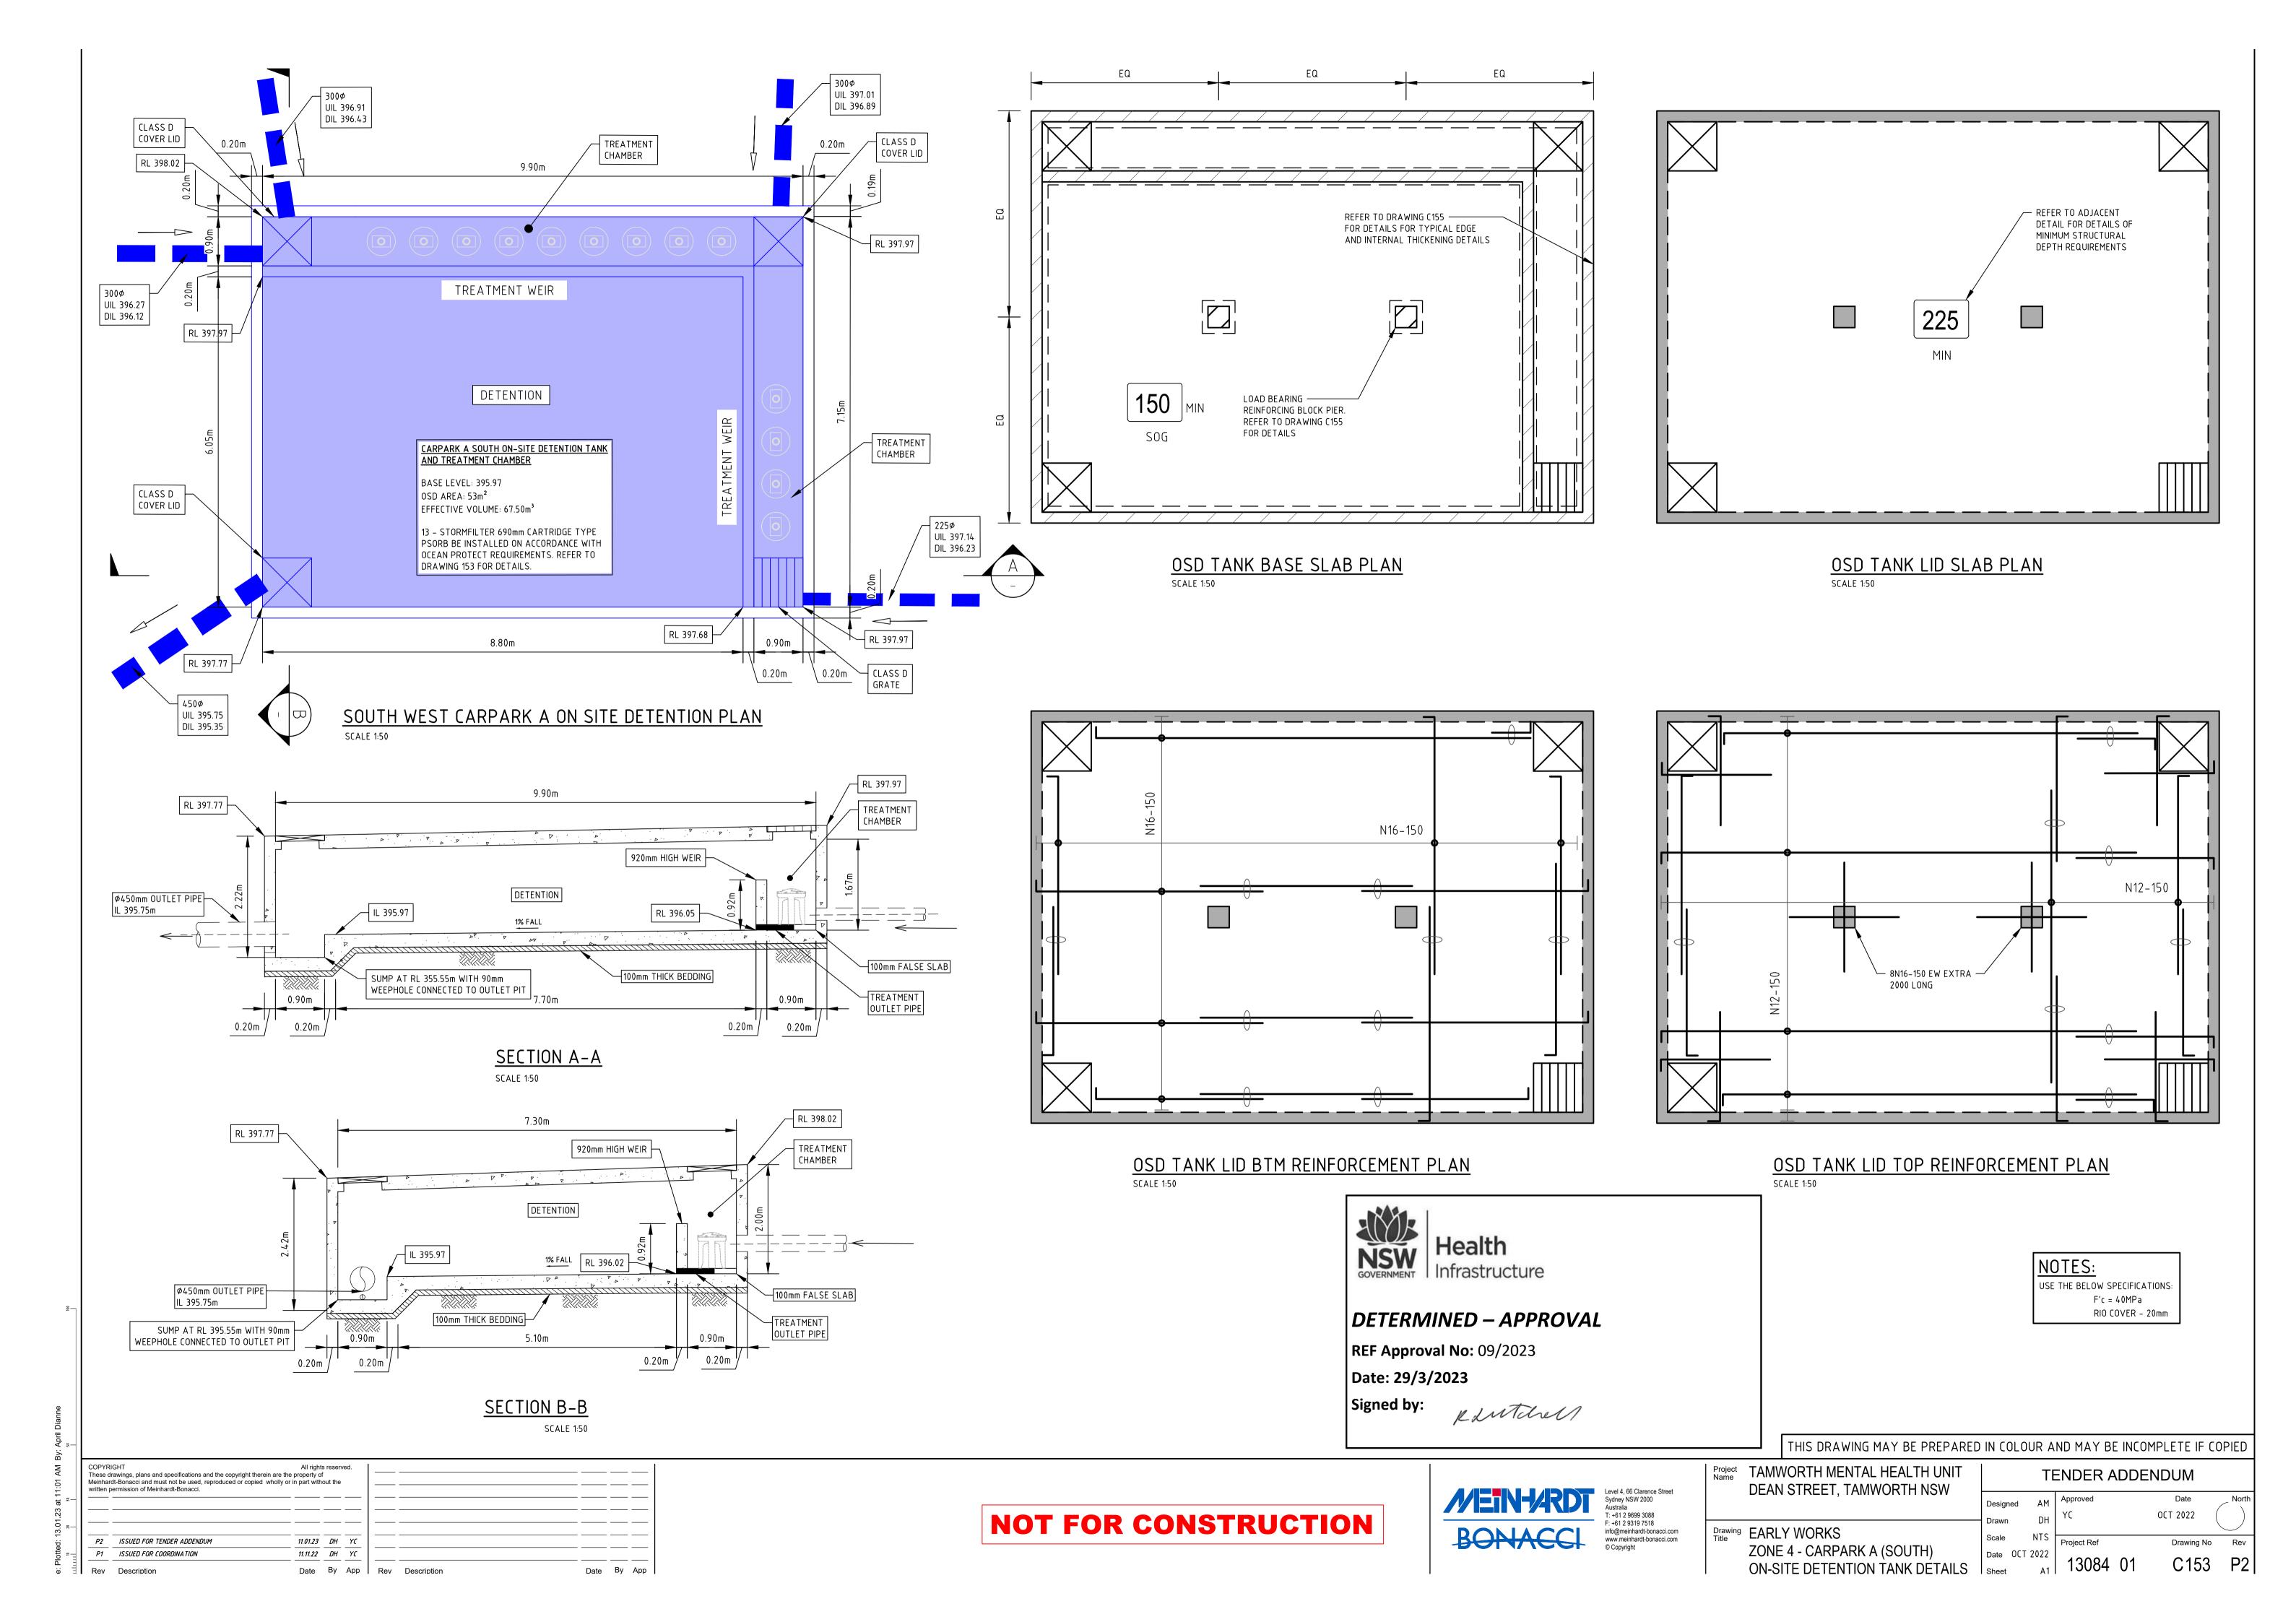




DETERMINED – APPROVAL

REF Approval No: 09/2023

Date: 29/3/2023

Signed by:


RLutchell

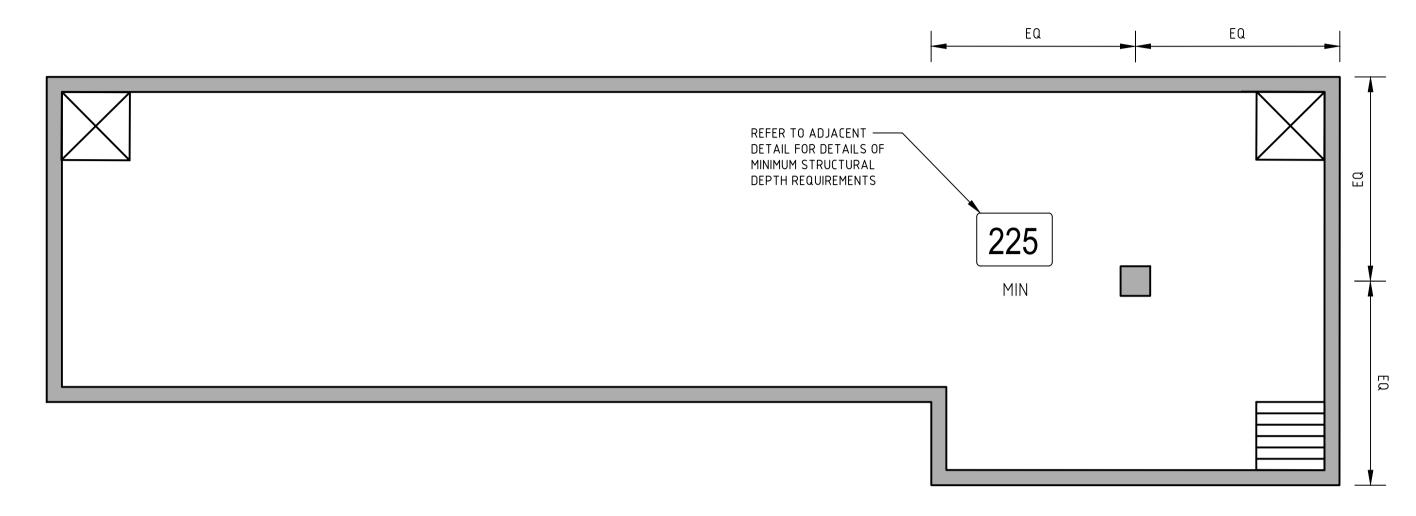

8N16-150 EW EXTRA ____ 2000 LONG N12-150

OSD TANK LID SLAB PLAN SCALE 1:50

OSD TANK LID TOP REINFORCEMENT PLAN
SCALE 1:50

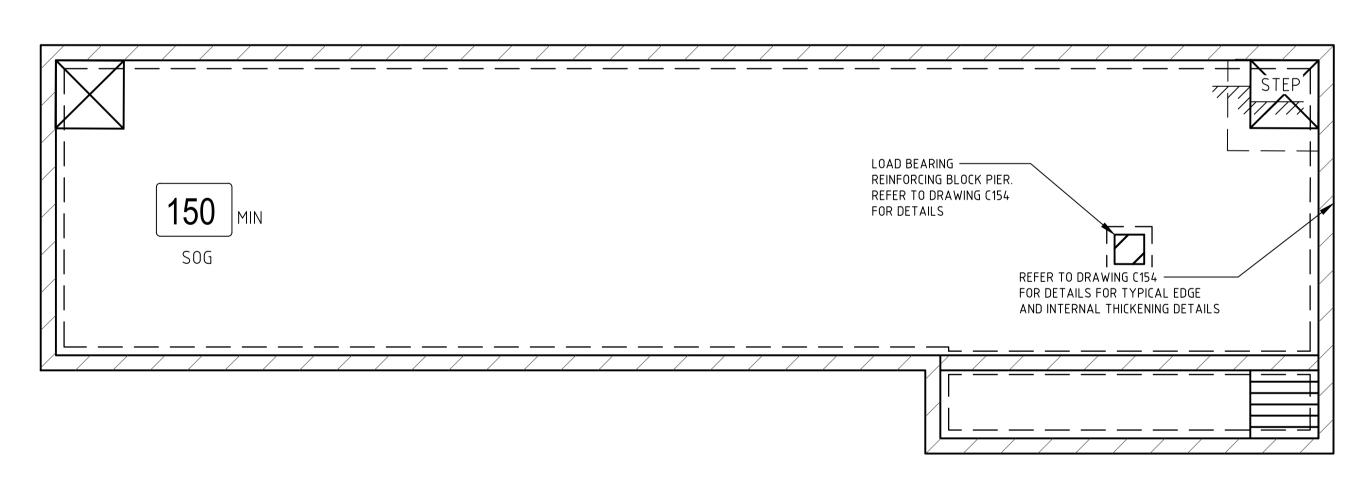

N16-150

OSD TANK BASE SLAB PLAN
SCALE 1:50

OSD TANK LID BTM REINFORCEMENT PLAN
SCALE 1:50

USE THE BELOW SPECIFICATIONS: RIO COVER - 20mm

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Project Name		TAMWORTH MENTAL HEALTH UNIT DEAN STREET, TAMWORTH NSW	TENDER ADDENDUM				
EARLY WORKS		•	Designed	AM DH	Approved YC	Date OCT 2022	North
Drawing Title	ZONE	2 - CARPARK B (NW)	Drawn Scale	NTS	Project Ref	Drawing No.	Rev



DETERMINED – APPROVAL

REF Approval No: 09/2023

Date: 29/3/2023

Signed by: RANTCHEM


ORIENTATION OF DECKING
SHOWN IS INDICATIVE AND AS
REQUIRED BY BUILDER. DETAIL
SIMILAR IF BONDEK SPAN IS
PERPENDICULAR TO BAR


VOICED ON PLANS


DETAIL OF SLAB DEPTH WITH PERMANENT FORMWORK


SCALE: 1:20


LAYING SEQUENCE SHOWN

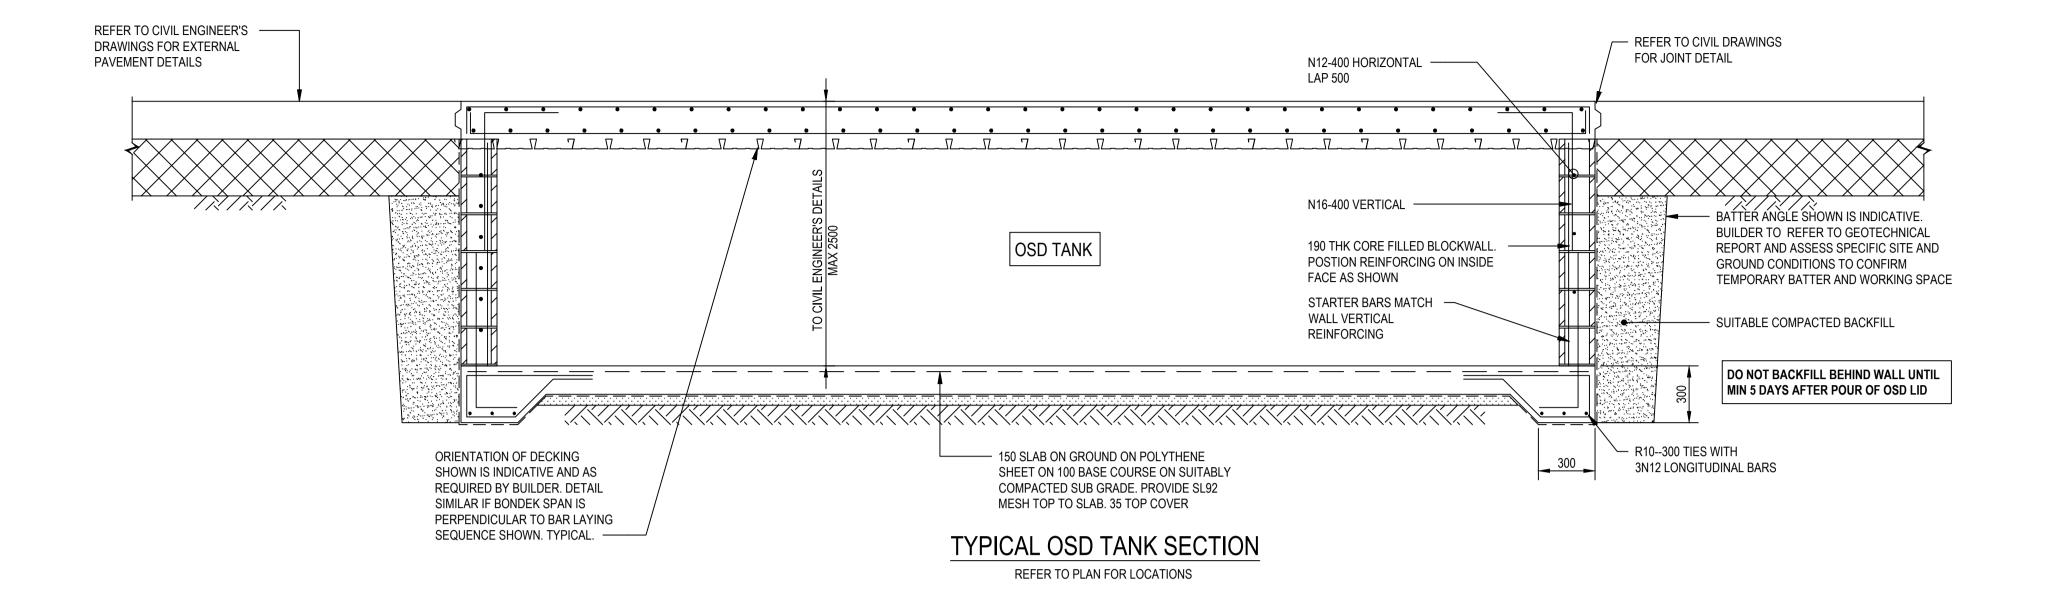

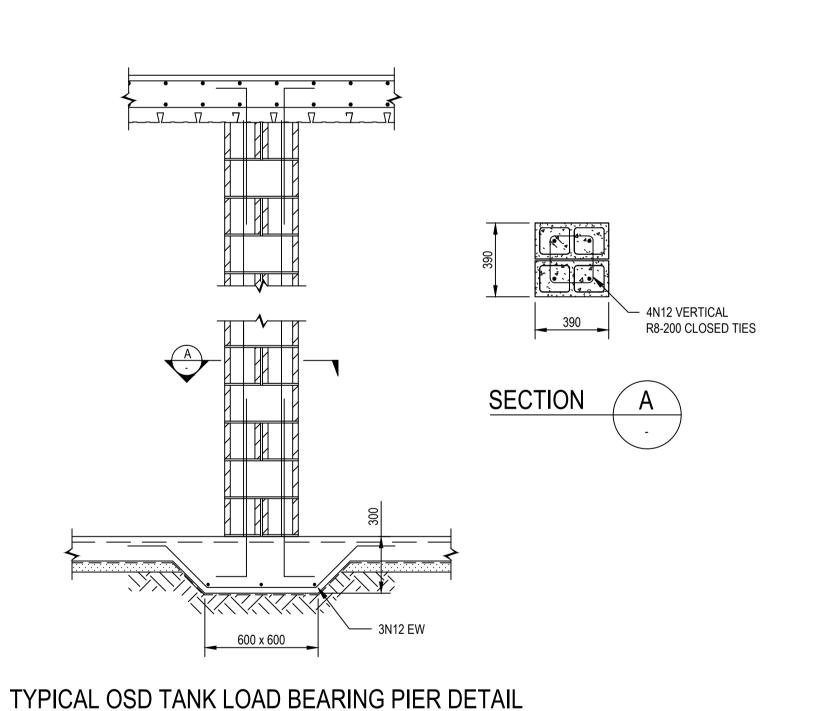

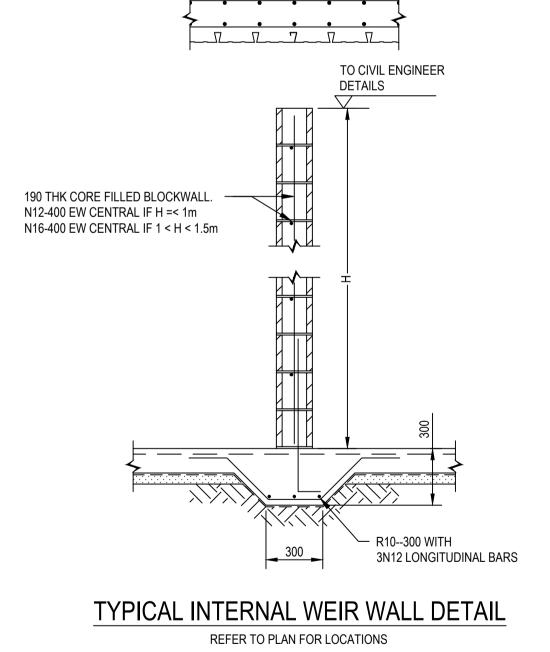

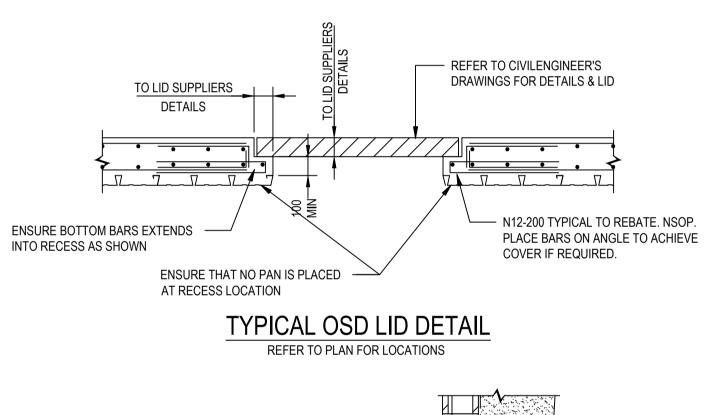

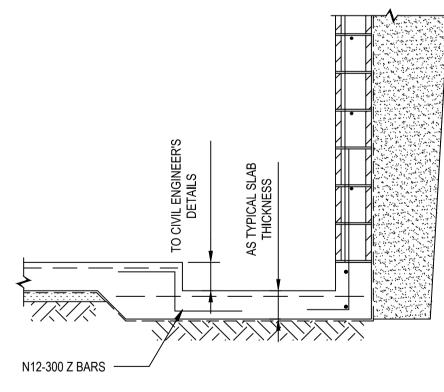

OSD TANK SUMP DETAIL
REFER TO PLAN FOR LOCATIONS

NOTES:

USE THE BELOW SPECIFICATIONS:

F'c = 40MPa

RIO COVER - 20mm

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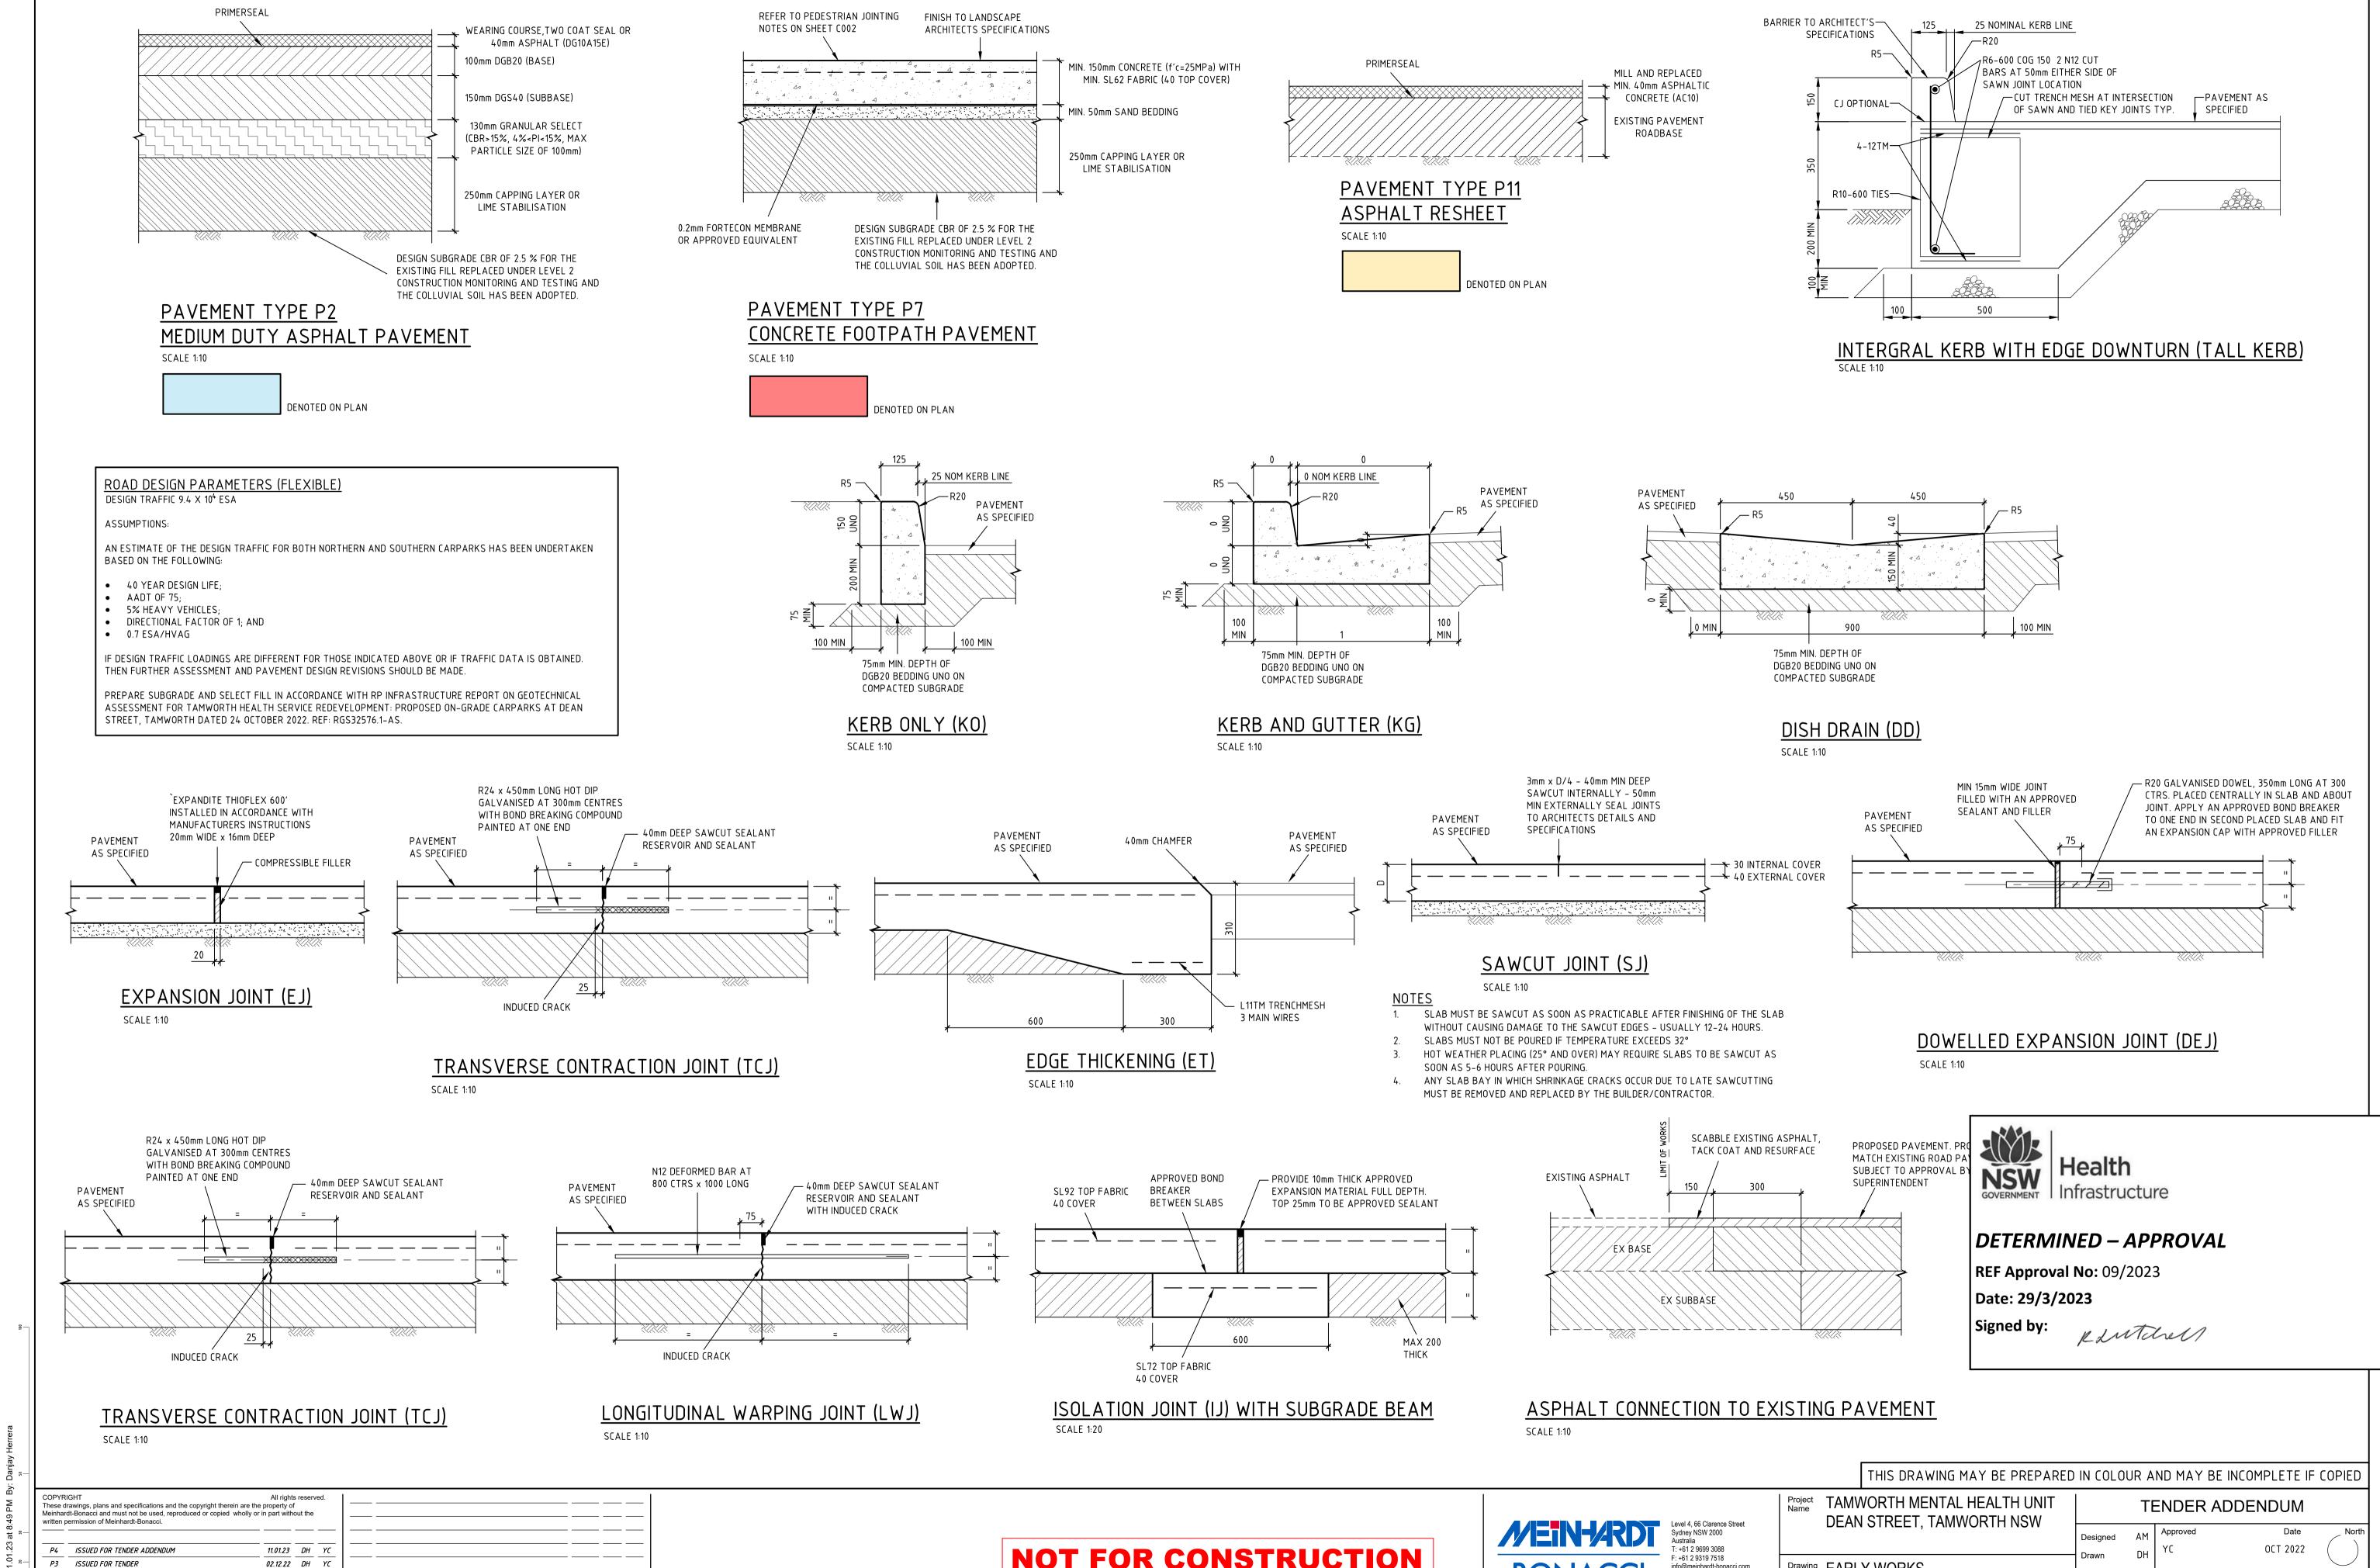
P2 ISSUED FOR TENDER ADDENDUM
11.01.23 DH YC
Rev Description
Date By App Rev Description
Date By App

REFER TO PLAN FOR LOCATIONS

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		TOTALLI, TAMINION	Designe	ed Al	Μ	Approved		Date	North			
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ISSUED FOR COORDINATION

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11.11.22 DH YC

28.10.22 DH Y

Date By App

Rev Description

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13084 01

C170 P4